
Waikato District Council **Building Consent Number** BLD2251/21

		BLD2251/21				
	DRAWING SCHEDULE					
LAYOUT ID	LAYOUT NAME	APPROVED				
01	INDEX/SITE LOCALITY					
02	PROJECT NOTES					
03	PROJECT NOTES					
04	SITE PLAN					
05	SITE & CONCRETE SETOUT PLAN					
06	FOUNDATION SETOUT PLAN					
07	FOUNDATION PLAN					
08	FOUNDATION DETAILS					
09	FOUNDATION DETAILS					
10	PLUMBING PLAN/ DETAILS					
11	FLOOR PLAN					
12	DIMENSIONED FLOOR PLAN					
13	ELEVATIONS E01 & E02					
14	ELEVATIONS E03 & E04					
15	CROSS SECTION A-A					
16	CROSS SECTION B-B					
17	ROOF LAYOUT PLAN					
18	ROOF FRAMING & SETOUT PLAN					
19	BUILDABLE TRUSS LAYOUT					
20	ROOF BRACING PLAN					
21	LINTEL, STUDS & FIXINGS PLAN					
22	TOP PLATE CONNECTIONS					
23	WALL BRACING PLAN					
24	WALL BRACING CALCULATIONS					
25	BRICK VENEER DETAILS					
26	BRICK VENEER DETAILS					
27	CLADDING DETAILS					
28	CLADDING DETAILS					
29	HWS & WET AREA DETAILS					
30	BATHROOM LAYOUTS & ELEVATIONS					
31	WINDOW,DOOR & H1 SCHEDULES					
32	SED STORMWATER DESIGN					
33	SED STORMWATER DESIGN					
34	ASBUILT DRAINAGE PLAN FOR CONTI	RACTOR USE ON SITE				

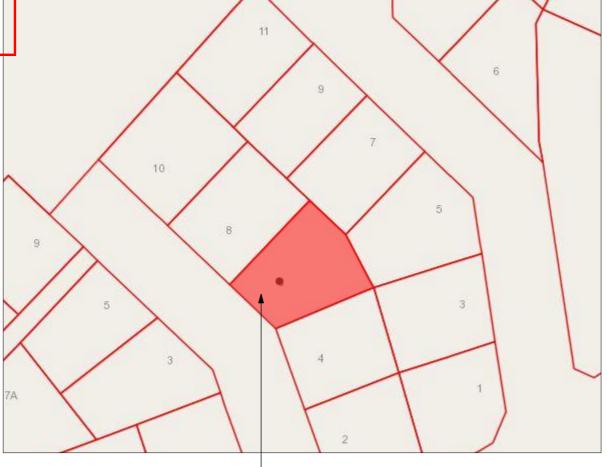

**BUILDING SITE** 

CONSULTANT SCHEDULE COMPLIANCE
ALL ARCHITECTURAL DRAWINGS SHALL BE READ IN CONJUNCTION WITH ENGINEERING DRAWINGS & CALCULATIONS. READ REPORTS BEFORE COMMENCING CONSTRUCTION. **ENSURE REQUIREMENTS ARE COMPLIED WITH DURING** CONSTRUCTION.

ANY VARIATIONS FROM THESE DRAWINGS & DOCUMENTS SHALL BE DISCUSSED WITH FRANKLIN ARCHITECTURAL DESIGN PRIOR TO ANY CHANGES ON SITE.

DIMENSIONS SHALL BE VERIFIED ON SITE BEFORE COMMENCING CONSTRUCTION.

SITE LEVELS SHALL BE CONFIRMED ON SITE BY CONTRACTOR BEFORE COMMENCING CONSTRUCTION

## **GEOTECHINCAL REPORT**

**Derek Booth Consultancy Ltd** info@dbcon.co.nz PHONE: 0800 23 22 66

REF: 180815

## STRUCTURAL ENGINEER

TILSLEY ENGINEERING LTD Zahid: zahid@teng.co.nz PHONE: 09 238 3245 REF: 16125

# **BUILDABLE TRUSS DESIGN/ PS1**

**DAYLE ITM** PHONE: 09 828 9791 REF: BTL00031

REFER SHEET 20 & PRODUCER STATEMENT/LINTEL DEISIGN/CALCULATIONS IN SPECIFICATION ADDENDUM ATTACHED.



ARTISTS IMPRESSION ONLY

NOTE: CONTRACTOR SHALL CONFIRM DATUM SOURCE ON SITE PLAN BEFORE COMMENCING CONSTRUCTION

KBR

01

SCALE

	REV NO.   REVISION:	BY: DATE:	•		PROPOSED RESIDENCE		DRAWN	KBR	DF
CONTRACTOR SHALL VERIFY ALL DIMENSIONS ON SITE			1 A tranklin		FROFOGLD RESIDENCE				
BEFORE COMMENCING CONSTRUCTION.			The second secon		FOR	DRAWING TITLE	CHECKED	KB	
WRITTEN DIMENSIONS SUPERSEDE SCALED DIMENSIONS.			\rchitectural	Find us at	Waikare Estate Limited	DIVINIO IIIEE	PROJECT NUMBER:	21 3710	
REFER TO SPECIFICATIONS FOR RELEVANT TRADE			design	www.franklinarchitectural.co.nz	Walkare Estate Ellilited				
CODES/REFERENCE DOCUMENTS WHICH FORM PART OF THIS			/		AT	INDEX/SITE LOCALITY	REVISION:	WD01	
CONTRACT.			PO Box 11019, Palm Beach 3118		6 RYLSTONE WAY. TE KAUWHATA		PLOT DATE	19/05/2021	
			Ph 09 239 2663 admin@fads.co.nz		O KIESTONE WAT, IE KAOWIIATA		PLOIDAIE	19/03/2021	

Version: 1, Version Date: 21/06/2021

# **PROJECT NOTES:**

WIND ZONE - HIGH **EARTHQUAKE ZONE -1 DURABILITY ZONE -B ROOF WEIGHT - LIGHT ROOF PITCH - 25 DEGREES** 

### DURABILITY: C

REFER DURABILITY TABLE IN PLANS

EXPOSURE ZONE B (AS DEFINED BY NZS3604:2011 4.5.2)

"CLOSED" - DRY INTÈRNAL LOCATIONS, NOT SUBJECT TO AIRBORNE SALT OR

"SHELTERED": - OPEN TO AIRBORNE SALTS, BUT NOT RAIN WASHED, SHALL BE ABOVE 45° LINE DRAWN FROM LOWER EDGE OF A PROJECTING WEATHERTIGHT STRUCTURE SUCH AS A FLOOR, ROOF OR DECK.

CONTRACT SHALL BE NZS 3910 UNLESS OTHERWISE STATED

CONSTRUCTION SHALL COMPLY WITH NZS 3604:2011 AND FOLLOWING SECTIONS OF THE NEW ZEALAND BUILDING CODE B1/AS1/VM1/VM4 STRUCTURE

DURABILITY C1-6/AS1 FIRE SAFETY D1/AS1 **ACCESS ROUTES** F1/AS1 SURFACE WATER E2/AS1/AS3 EXTERNAL WATER E3/AS1 INTERNAL WATER

HAZARDOUS BUILDING MATERIALS F2/AS1 F4/AS1 SAFETY FROM FALLING

F5/AS1 CONSTRUCTION & DEMOLITION HAZARDS

F7/AS1 WARNING SYSTEMS G1/AS1 PERSONAL HYGIENE

G2/AS1 LAUNDERING

FOOD PREPARATION & PREVENTION OF CONTAMINATION G3/AS1 G4/AS1 **VENTILATION** 

G5/AS1 INTERIOR ENVIRONMENT G6/AS1 AIRBORNE & IMPACT SOUND G7/AS1 NATURAL LIGHT G8/AS1 ARTIFICIAL LIGHT

G10/AS PIPED SERVICES GAS AS AN ENERGY SOURCE G11 / AS<sup>2</sup> G12/AS1

WATER SUPPLIES G13/AS3 FOUL WATER H1/AS1 **ENERGY EFFICIENCY** 

ALL PLAN VARIATIONS OR PRODUCT CHANGES/SYSTEMS/AS BUILT DOCUMENTATION SHALL BE SUPPLIED TO THE MAIN CONTRACTOR AND BUILDING CONSENT AUTHORITY BEFORE A CODE OF COMPLIANCE CERTIFICATE CAN BE ISSUED

# OWNER BUILDING MAINTENANCE

REGULAR ONGOING MAINTENANCE SHALL BE CARRIED OUT BY OWNER TO ACHIEVE REQUIRED DURABILITY OF ALL MATERIALS, COMPONENTS AND

REFER TO SPECIFIC MANUFACTURERS LITERATURE FOR AL MAINTENANCE SCHEDULES AND PROCEDURES.

# REGULAR MAINTENANCE INCLUDES:

INSPECTION OF /WASHING EXTERIOR SURFACES / JUNCTIONS NO HIGH PRESSURE WATER SHALL BE DIRECTED AT ANY SENSITIVE JUNCTIONS

CONTRACTOR SHALL VERIFY ALL DIMENSIONS ON SITE

BEFORE COMMENCING CONSTRUCTION.
WRITTEN DIMENSIONS SUPERSEDE SCALED DIMENSIONS.

REFER TO SPECIFICATIONS FOR RELEVANT TRADE CODES/REFERENCE DOCUMENTS WHICH FORM PART OF THIS

CONTRACT.

REPAIR OR REPLACEMENT OF ITEMS TO MAINTAIN WEATHER TIGHTNESS OF BUILDING ENVELOPE

GUTTER SYSTEMS INSPECTED AND CLEANED OUT MONTHLY TO AVOID BLOCKING GUTTER SYSTEM.

FLASHINGS, CLADDINGS AND ROOF SYSTEMS INSPECTED EVERY QUARTER FOR SIGNS OF DETERIORATION. REPAIR ALL FAULTS WITHOUT DELAY AS SOON AS DISCOVERED.

# **DURABILITY OF NAILS & SCREWS**

.,	USED FOR FRAMING & CLADDING						
		NAIL O	R SCREW				
BUILDING LOCATION	CLADDING THAT ACTS AS BRACING (50 YEAR DURABILITY)	STRUCTURAL CLADDING (15-YEAR	"CLOSED"	"SHELTERED AREAS" <sup>(1)</sup>	FRAMING IN "EXPOSED" AREAS <sup>(1)</sup>		
Zone B & C	GALVANISED STEEL <sup>(4)</sup>	GALVANISED STEEL <sup>(4)</sup>	MILD STEEL(5)	-	GALVANISED STEEL <sup>(5)</sup>		

REV NO. REVISION:

COUNCIL RFI

RFI01

# Building Constrant Indundres

Waikato District Council

ALL CONSTRUCTION SHALL COMPLY WITH NZBC E2/AS1, NZS3604:2011
BLIND 2015 NG PROPRIETARY SPECIFICATIONS / DETAILS INCLUDED IN THE

PLANS AND SPECIFICATIONS.
REFER SPECIFICATIONS FOR RELEVANT TRADE CODES/REFERENCE
DOCUMENTS WHICH FORM PART OF THIS CONTRACT.

ESTABLISH FINISHED LEVELS ON SITE BEFORE COMMENCING

CONSTRUCTION.

DIMENSIONS SHALL BE VERIFIED ON SITE BEFORE COMMENCING CONSTRUCTION

WRITTEN DIMENSIONS SUPERCEDE SCALED DIMENSIONS

ALL ARCHITECTURAL DRAWINGS SHALL BE READ IN CONJUNCTION WITH **ENGINEERING DRAWINGS & CALCULATIONS** 

ALL CONTRACTORS ARE RESPONSIBLE FOR BUILDING CONSENT DOCUMENTATION AND SITE SAFETY REQUIREMENTS ARE COMPLIED WITH

SITE LEVELS SHALL BE CONFIRMED ON SITE BY CONTRACTOR BEFORE COMMENCING CONSTRUCTION

### SERVICES

ALL PLUMBING /DRAINAGE SHALL BE IN ACCORDANCE WITH AS/NZS

EXISTING SERVICES SHALL BE LOCATED AND IDENTIFIED AT PROPOSED CONNECTION POINTS BEFORE COMMENCING CONSTRUCTION.

CONTRACTOR SHALL LIAISE WITH AND ATTEND WHERE NECESSARY NETWORK UTILITY OPERATORS & COUNCIL AUTHORITIES FOR INSTALLATION

CONNECTIONS AND DRAINAGE SHALL BE COMPLETED IN ACCORDANCE WITH RELEVANT NZ CODES AND TERRITORIAL AUTHORITY REQUIREMENTS.

CONTRACTOR SHALL TAKE ALL NECESSARY PRECAUTIONS DURING EXCAVATION TO AVOID DISRUPTION TO EXISTING SERVICES AND REINSTATEMENT TO THEIR ORIGINAL CONDITION

## **CONSTRUCTION R-VALUES:**

REFER TO SPECIFICATION APPENDIX FOR DESIGN WORKSHEET. REQUIREMENTS ARE IN ACCORDANCE WITH NZBC H1/AS1. CLIMATE ZONE 2

NZS 4218:2009 CALCULATION METHOD.

INSTALL MANUFACTURERS SPECIFICATION ALL WALL/ ROOF AND SUBFLOOR

## H1 - DOWNLIGHTS

CONFIRM DOWNLIGHT SPECIFICATION COMPLIES WITH H1 REQUIREMENTS. DOWNLIGHTS SHALL HAVE NZECP 54 'CA', 'RA' OR 'OA' FITTINGS WITH INSULATION ABUTTED AGAINST FITTINGS.

## SHOWER GLASS/ DOORS

SHOWER GLASS & DOORS SHALL BE INSTALLED WITH TOUGHENED SAFETY GLASS IN ACCORDANCE WITH NZS 4223: PART 3:1999

ALL INTERNAL DOORS SHALL BE 2.0m HIGH HOLLOW CORE WITH ARCHITRAVES UNLESS OTHERWISE SPECIFIED.

# SURFACE FINISH

WALL LININGS ADJACENT TO APPLIANCES SHALL COMPLY WITH G3/AS1 CLAUSE 1.6. HYGIENIC SURFACE FINISHES

ALL TIMBER FRAMING SHALL COMPLY WITH NZS3604:2011 ALL STRUCTURAL TIMBER FRAMING SHALL BE SG8 UNLESS OTHERWISE

TIMBER TREATMENTSHALL COMPLY WITH NZBC B2/AS1 REFER TO DRAWINGS / SPECIFICATIONS AS TREATMENT VARIES ACCORDING TO LOCATION & DETAIL REQUIRED.

ALL INTERNAL ENCLOSED FRAMING H1.2 ALL EXTERNAL EXPOSED FRAMING H3.2 ALL TIMBER IN CONTACT WITH GROUND

INSTALL DPC UNDER ALL BOTTOM PLATES/TIMBER IN CONTACT WITH CONCRETE.

FRAMING SHALL BE FIXED TO FLOOR SLAB BY PROPRIETARY LUMBERLOK BOTTOM PLATE FASTENERS WITH 150mm OF EACH END OF THE PLATE AND BE SPACED AT A MAXIMUM. 900mm CENTRES FOR POURED INSITU CONCRETE SLABS

ALL PRODUCTS/ MATERIALS SHALL BE INSTALLED TO MANUFACTURERS

### JOINERY/ GLAZING

ALUMINIUM DOOR REBATES- CONFIRM DOOR REBATE POSITION AND SIZE WITH OWNER/SITE SUPERVISOR BEFORE COMMENCING FABRICATION OF DOORS

ALL JOINERY DETAILS SHALL COMPLY WITH NZBC E2/AS1 FIGURE 71 - GENERAL HEAD FLASHINGS

FIGURE 72 A/B - GENERAL JAMB/SILL DETAILS FIGURE 73 C/D - BRICK VENEER

FIGURE 86- CAVITY FIX RUSTICATED WEATHERBOARDS FIGURE 91 - CAVITY FIX FIBRE CEMENT WEATHERBOARDS

LEAD CONTRACTOR IS RESPONSIBLE FOR WEATHER TIGHTNESS OF SYSTEM ON SITE.

WINDOWS TO BATHROOMS/TOILETS/ SERVICE AREAS SHALL BE OPENABLE

MIN REQUIREMENT: 5% OPENING WINDOWS BASED ON INDIVIDUAL SERVICED ROOM FLOOR AREA

'MARSHALL INNOVATIONS PROTECTO SILL SYSTEM® 'SILL SYSTEM TO ALL WINDOW / DOOR OPENINGS TO COMPLY WITH WANZ WIS WINDOW INSTALLATION SYSTEM DETAILS (EXCLUDING HEAD FLASHING DETAILS) FOR CAVITY CONSTRUCTION. GLAZING SHALL COMPLY WITH NZS 4223 (2008 AMENDMENTS) DOUBLE GLAZING TO ALL WINDOWS AND DOOR JOINERY EXCLUDING GARAGE ALL GLAZING SHALL BE CLEAR FLOAT EXCEPT FOR OBSCURE GLASS TO BATHROOMS AND TOILETS. JOINERY MANUFACTURER SHALL CONFIRM LOCATION OF SAFETY GLASS AS REQUIRED BY CODE.

## BUILDING UNDERLAY SYSTEM

BUILDING WRAP - THERMAKRAFT WATERGATE PLUS USE POLYPROPYLENE TAPE TO SUPPORT BUILDING WRAP AND INSULATION -HORIZONTALLY AT 300MM CENTRES PLUS OVER NOGS AND VERTICALLY TO MATCH STUDS SPACING'S.

## 70 SERIES BRICK VENEER ON 50mm CAVITY.

WALL TIES PLACEMENT:

TOP OF VENEER PANEL/TOP OF PANELS UNDER OPENING: 300mm MAX OR TWO COURSES (WHICHEVER IS THE SMALLER) OF TOP OF VENEER. UNSUPPORTED PANEL SIDES AND EDGES OF OPENINGS: 300mm MAX TO PANEL SIDE OR EDGE

VENEER PANEL BASE IN MASONRY REBATE SHALL BE SEALED WITH 2 COATS. SIKA BLACKSEAL PLUS LIQUID APPLIED DAMP PROOF COURSE

BRICK VENEER TIES SHALL COMPLY WITH AS/NZS 2699.1: PLACE TIES TO:

- NZS 4210: 2.9.5 TIE ANCHORAGE, COVER AND FIXING; AND
- NZS 4210: 2.9.6 PLACING OF TIES
- NZS 4210: 2.9.7 TIE CLASSIFICATION AND SPACING AT UNSUPPORTED EDGES AND AT ALL OPENINGS THROUGH VENEERED WALLS OR NON GROUTED CAVITY WALLS, WALL TIES TO BE PROVIDED:
- AT THE TOP AND BOTTOM OF THE OPENING:
- NOT MORE THAN 300MM OR 2 COURSES, WHICHEVER IS THE SMALLER
- AT THE SIDES OF THE OPENING OR AT AN UNSUPPORTED EDGE:
- NOT MORE THAN 300MM
- WHERE THE VENEER WALL CONTINUES ABOVE OR IS INTERRUPTED BY A DAMP-PROOF COURSE OR WATERPROOF MEMBRANE, WALL TIES SHALL BE PROVIDED IN EACH OF THE FIRST TWO COURSES ABOVE THE MEMBRANE.

BRICK TIES SHALL BE AT 400MM C/C FOR WALL HEIGHTS OVER 2.455m HIGH. VENEER STUDS SHALL BE AT 400MMC/C FOR WALLS SUPPORTING BRICK VENEER HIGHER THEN 2.455m HIGH

TIES SHALL BE SCREW FIXED (IE NON IMPACT METHOD) USING CORRECT DURABILITY ZONE SCREWS

ROOFING: 25° ROOF

COLORSTEEL CORRUGATED ENDURA LONGRUN 0.4 GAUGE FIX WITH APPROVED SCREWS DRISTUD RU24 ROOF UNDERLAY

MAINTAIN MIN. 25mm GAP CLEARANCE BETWEEN INSULATION & ROOF LINDERI AY

H1.2 SG8 70x45 PURLINS @ 900mm C/C

NOTE: 800mm END SUPPORT TO COMPLY WITH NZBC E2/AS1 FIG 45 WHERE

## JAMES HARDIE LINEA WEATHERBOARD SYSTEM:

CLADDING SYSTEM SHALL BE INSTALLED TO MANUFACTURERS DETAILS AND SPECIFICATIONS 16mm THICK 4200mm LONG BEVEL BACK PROFILE BRANZ APPRAISAL

447/CODEMARK CERTIFIED WEATHERBOARD OVER 20mm DRAINED CAVITY

REFER DESIGN AND JUNCTION MANUAL

CONTRACTOR SHALL COMPLETE JH WEATHERBOARD CHECKLIST INCLUDING SUPPLY OF HARDCOPY TO LOCAL AUTHORITY AS PART OF ENGAGEMENT

### TRUSSES

REFER TRUSS MANUFACTURERS PRODUCER STATEMENT FOR ADDITIONAL LOAD BEARING REQUIREMENTS TO SUPPORT ROOF LOADS.

TRUSS MANUFACTURERS PRODUCER STATEMENT SHALL TAKE PRECEDENCE OVER PLANS.

### FLASHINGS

0.55 BMT FLASHINGS - COATING FINISH SHALL MATCH ROOF REFER NZBC E2/AS1: 2011 AND NZ ROOF AND WALL CLADDING CODE OF PRACTICE FOR ALL FLASHINGS.

WEATHERTIGHT FLASHINGS: HIPS, RIDGES, BARGES /SEALS SHALL COMPLY WITH NZBCE2/AS1.

FLASHING MATERIALS:

GUTTERS AND FIXINGS SHALL COMPLY WITH NZBC E2/AS1 -TABLE 20 FLASHINGS SHALL BE COMPATIBLE WITH MORTAR/BEDDING IN ACCORDANCE WITH TABLE 21 & 22.

JAMES HARDIE 4.5mm HARDIE SOFFIT LINING TO SOFFITS WITH BUTT JOINTS UNLESS OTHERWISE SPECIFIED IN LARGE SOFFIT AREAS. ALL SOFFIT LINING WORK SHALL BE IN ACCORDANCE WITH JAMES HARDIE INSTALLATION MANUAL AND SPECIFICATIONS.

### STUD FRAMING

TIMBER TREATMENT SHALL COMPLY WITH NZBC B2/AS1 STUDS SHALL COMPLY WITH NZS3604:2011 TABLE 8.2

NOGS @ 800mm C/C TYPICALLY VERTICALLY - CLADDING REQUIREMENTS MAY OVERRIDE

- CONTRACTOR SHALL VERIFY INTERNAL LINING FIXING REQUIREMENTS BEFORE COMMENCING CONSTRUCTION

# LINTELS

THE LINTELS HAVE BEEN SIZED USING THE FOLLOWING: ALL SG8 TO NZS3604:2011.

hyONE LINTEL HAS BEEN SIZED USING THE designIT FOR HOUSES NEW ZEALAND SERIES 8 SOFTWARE.

### STRUCTURE CONCRETE

MIN CONCRETE COVER TO STEEL REINFORCEMENT: CONCRETE PLACED DIRECT ON/AGAINST GROUND: 75mm ALL OTHER SITUATIONS WHERE CONCRETE IS PLACED IN FORMWORK (REFER 4.5.2): 50mm

TOP OF WALL /FLOOR SLAB IN A CLOSED AREA: 30mm - INCLUDES ALL **EXPOSED FINISH SLAB SURFACES** 

DIRECT WEARING CONCRETE FLOORS SHALL COMPLY WITH NZS3101 TABLE MINIMUM SPECIFIED CONCRETE STRENGTH AT 28 DAYS SHALL BE

(NZS3604:2011 4.5.2): -20MPA: ALL REINFÓRCED CONCRETE EXPOSED TO WEATHER IN ZONE C

# **ENGINEERED RIBRAFT FOUNDATIONS -**

CONSTRUCTION SHALL COMPLY WITH ENGINEERS SPECIFIC DESIGN AND SPECIFICATIONS.

25mm DEEP GARAGE DOOR REBATE - CONFIRM DEPTH AND SET OUT TO SUIT GARAGE DOOR MANUFACTURER. PROVIDE 50mm GROUND CLEARANCE TO F.L. IN ACCORDANCE WITH NZBC E2/AS1.

120mm DEEP SLAB REBATE FOR BRICK VENEER WALL CLADDING.

85mm THICK 20MPa CONCRETE SLAB REINFORCED WITH GRADE 500E SE62 2.294ka/m<sup>2</sup> MESH

# **SMOKE DETECTORS**

AUTOMATIC SMOKE DETECTION AND ALARM SYSTEM IS REQUIRED IN EACH SLEEPING ROOM OR WITHIN 3.0m OF EACH SLEEPING ROOM DOOR AND BE ABLE TO BE HEARD FROM THE OTHER SIDE OF THE CLOSED REFER APPROVED DOCUMENT NZBC F7

AUTHORITY AS COMPLYING WITH LEAST ONE (1) OF: UL 217, ULC S531, AS 3786, BS 5446 PART 1

SMOKE ALARMS SHALL BE LISTED OR APPROVED BY A RECOGNIZED

# NOTE: CONTRACTOR SHALL CONFIRM DATUM SOURCE

02

SCALE

PROPOSED RESIDENCE DRAWING TITLE **Waikare Estate Limited** 

ON SITE PLAN BEFORE COMMENCING CONSTRUCTION KBR ING NUMBE

KΒ PROJECT NUMBER: 21 3710 **PROJECT NOTES** REVISION WD01 6/07/2021

CHECKED

BY: DATE

02/07/21

design PO Box 11019, Palm Beach 3118


franklin


\rchitectural


Find us at www.franklinarchitectural.co.nz

**6 RYLSTONE WAY, TE KAUWHATA** 

PLOT DATE

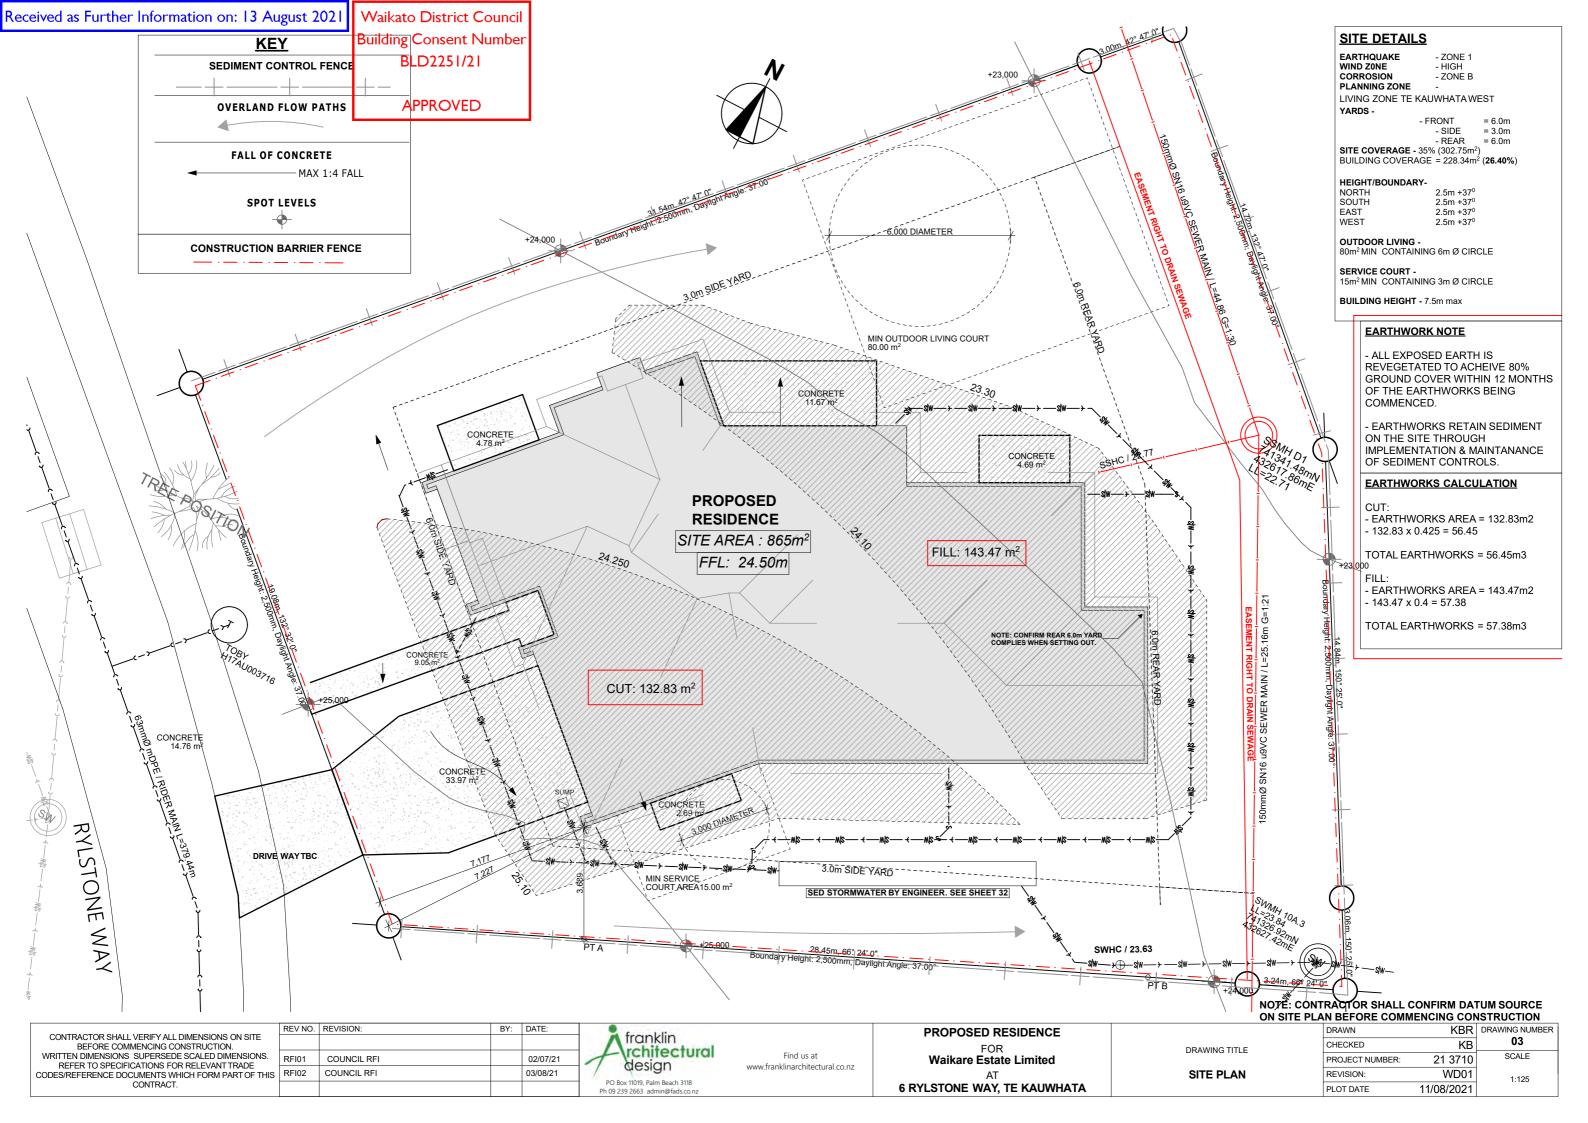

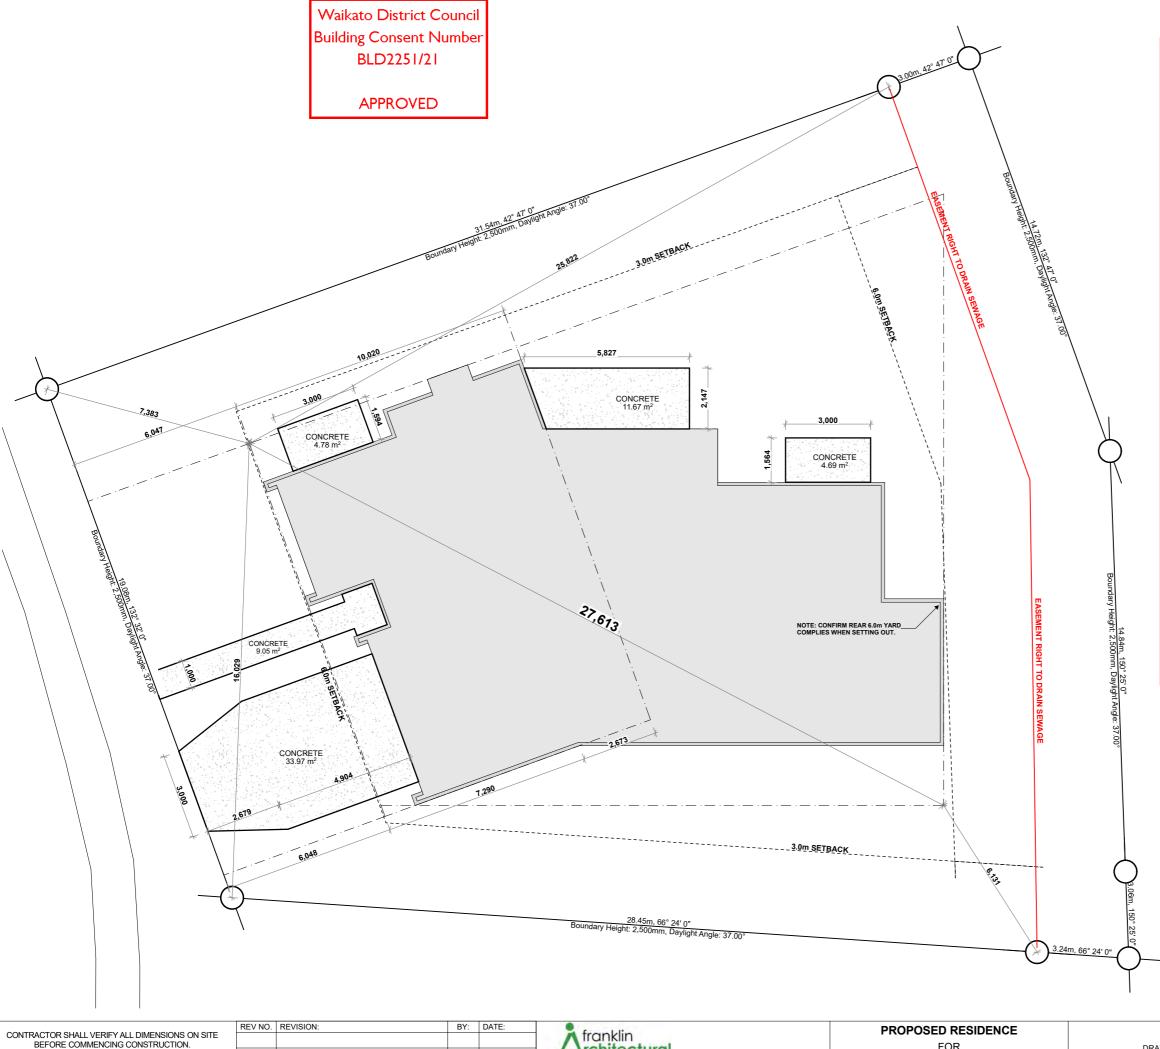

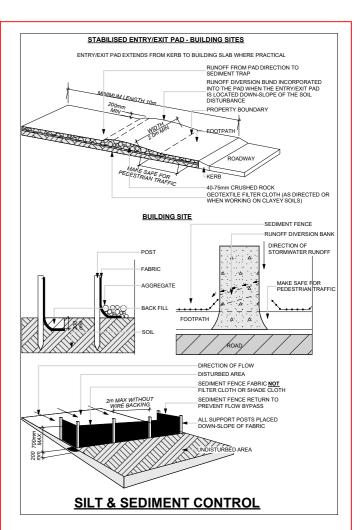

SEDIMENT AND EROSION CONTROL MEASURES SHALL BE THE RESPONSIBILITY OF THE MAIN CONTRACTOR AND SHALL BE REGULARLY CHECKED AND MAINTAINED AS REQUIRED DURING CONSTRUCTION - REFER SITE PLAN KEY FOR ALL CUT/FILL ZONES.

SEDIMENT AND RUNOFF CONTROL SHALL BE DESIGNED AND INSTALLED BY THE SITE LICENCED BUILDING PRACTITIONER PRIOR TO OR DURING PROJECT EARTHWORKS.

NOTE: CONTRACTOR SHALL CONFIRM DATUM SOURCE ON SITE PLAN BEFORE COMMENCING CONSTRUCTION

CONTRACTOR SHALL VERIFY ALL DIMENSIONS ON SITE
BEFORE COMMENCING CONSTRUCTION.
WRITTEN DIMENSIONS SUPERSEDE SCALED DIMENSIONS.
REFER TO SPECIFICATIONS FOR RELEVANT TRADE
CODES/REFERENCE DOCUMENTS WHICH FORM PART OF THIS
CONTRACT.


franklin rchitectural design
PO Box 11019, Palm Beach 3118 Ph 09 239 2663 admin@fads.conz

Find us at www.franklinarchitectural.co.nz PROPOSED RESIDENCE
FOR
Waikare Estate Limited
AT
6 RYLSTONE WAY, TE KAUWHATA

DRAWING TITLE

SITE & CONCRETE SETOUT PLAN

_	THE BEI CITE COMMENCING CONCINCOTION							
	DRAWN	KBR	DRAWING NUMBER					
	CHECKED	KB	04					
	PROJECT NUMBER:	21 3710	SCALE					
	REVISION:	WD01	N.T.S 333					
	PLOT DATE	6/07/2021						

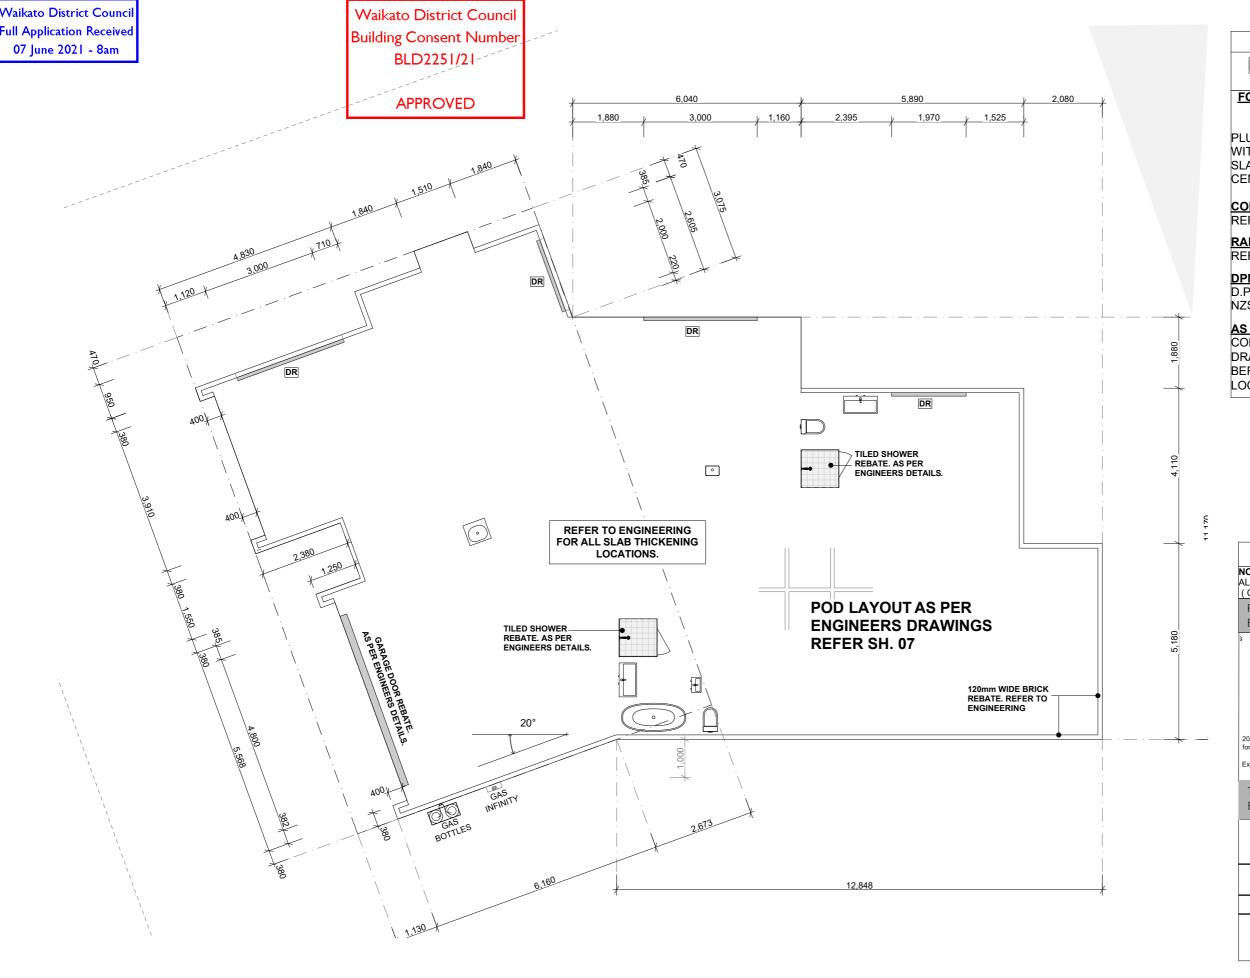

**KEY PLAN** DR 25mm DEEP DOOR REBATE

# **FOUNDATION NOTES: REFER ENGINEER DRAWINGS FOR FINAL FOUNDATION REQUIREMENTS**

PLUMBER SHALL CONFIRM ALL WASTE POSITIONS WITH MAIN CONTRACTOR BEFORE PLACEMENT IN SLAB ALL PLUMBING FIXTURES ARE DIMENSIONED TO CENTRE OF UNIT FIXTURE FROM FLOOR SLAB EDGE

# **CONCRETE SLAB:**


REFER TO ENGINEERS DETAILS

REFER TO ENGINEERS DETAILS

D.P.M MINIMUM 0.25mm THICK POLYTHENE SHEET TO NZS 3604:2011

# AS BUILT PLANS

CONTRACTOR SHALL SUPPLY ACCURATE AS-BUILT DRAWINGS OF ALL SERVICES IN THE GROUND BEFORE COVERING AND SUPPLY AS BUILT PLANS TO LOCAL AUTHORITY

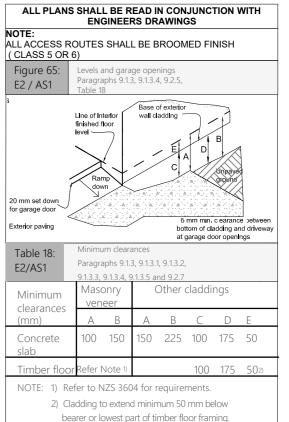


# NOTE: CONTRACTOR SHALL CONFIRM DATUM SOURCE ON SITE PLAN BEFORE COMMENCING CONSTRUCTION

REV NO. REVISION: KBR PROPOSED RESIDENCE CONTRACTOR SHALL VERIFY ALL DIMENSIONS ON SITE
BEFORE COMMENCING CONSTRUCTION.
WRITTEN DIMENSIONS SUPERSEDE SCALED DIMENSIONS.
REFER TO SPECIFICATIONS FOR RELEVANT TRADE
CODES/REFERENCE DOCUMENTS WHICH FORM PART OF THIS franklin 06 CHECKED KB rchitectural DRAWING TITLE Find us at SCALE **Waikare Estate Limited** PROJECT NUMBER: 21 3710 design www.franklinarchitectural.co.nz **FOUNDATION SETOUT PLAN** REVISION: WD01 PO Box 11019, Palm Beach 3118 CONTRACT. 6 RYLSTONE WAY, TE KAUWHATA PLOT DATE 19/05/2021

Document Set ID: 3154607

Version: 1, Version Date: 21/06/2021

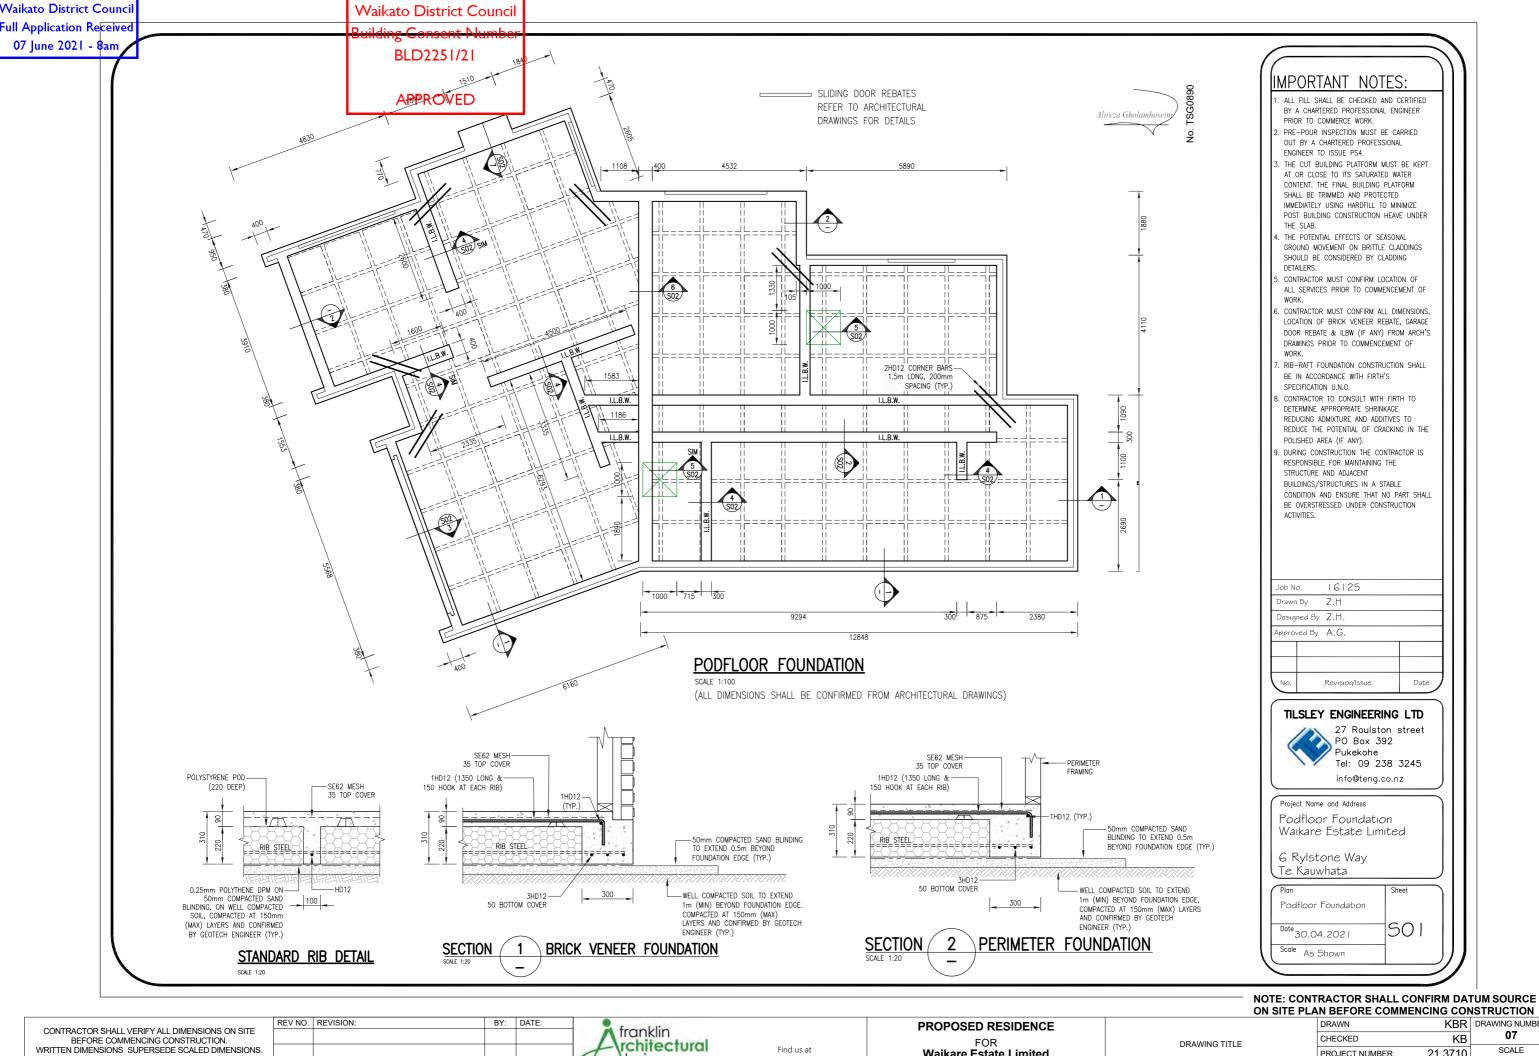

REFER TO SPECIFICATIONS FOR RELEVANT TRADE CODES/REFERENCE DOCUMENTS WHICH FORM PART OF THIS CONTRACT.


rchitectural design PO Box 11019, Palm Beach 3118

Find us at www.franklinarchitectural.co.nz

**Waikare Estate Limited 6 RYLSTONE WAY, TE KAUWHATA** 

**FOUNDATION PLAN** 

07 CHECKED KΒ SCALE PROJECT NUMBER: 21 3710 REVISION: WD01 N.T.S PLOT DATE 19/05/2021

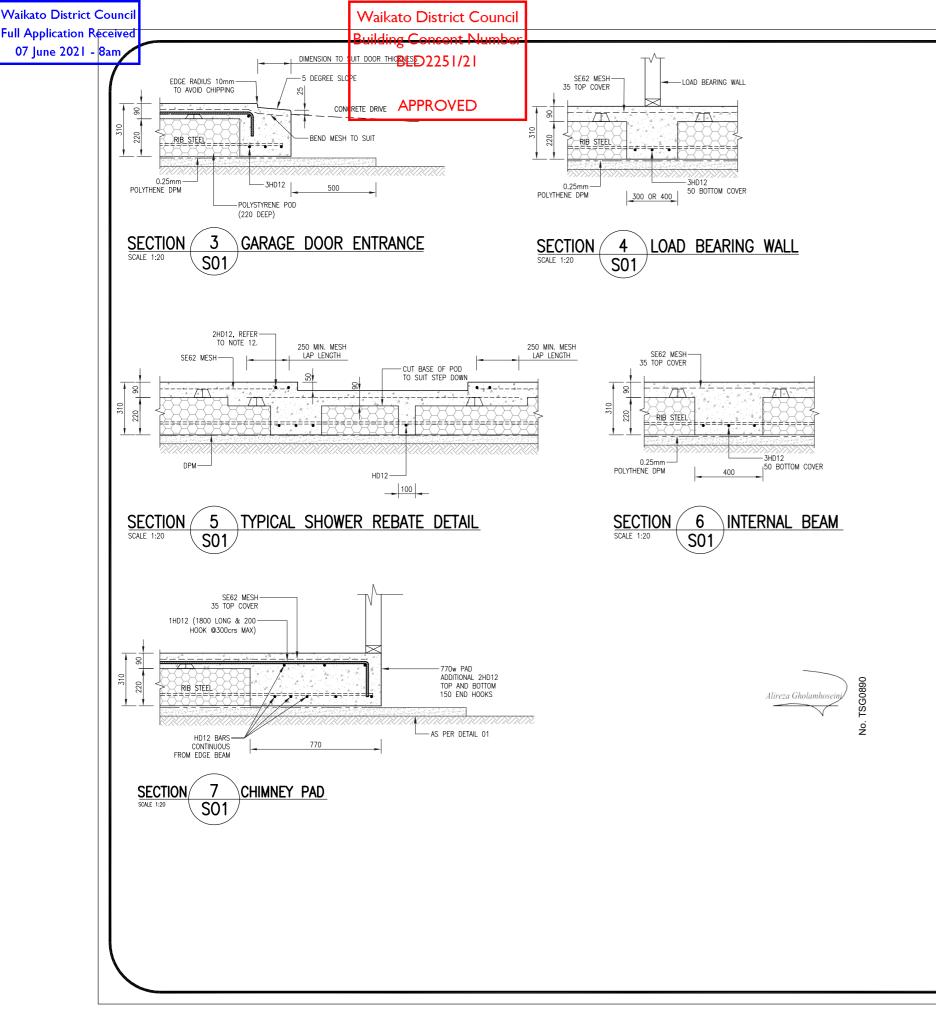

# CONCRETE

- ALL WORKMANSHIP AND MATERIAL SHALL COMPLY WITH NZS3109.
- CONCRETE STRENGTH TO BE AS SHOWN ON DRAWINGS AND SPECIFICATION OR IN ACCORDANCE WITH NZS3101.
- ARCHITECTS DRAWINGS SHOULD BE REFERED TO FOR ANY
- DURABILITY AND WATERPROOFING REQUIREMENTS.

  NO PENETRATIONS, CHASES OR EMBEDMENT OF PIPES OTHER THAN
- THOSE SHOWN ON STRUCTURAL DRAWINGS SHALL BE MADE IN CONCRETE MEMBERS WITHOUT THE PRIOR APPROVAL OF ENGINEER.

## REINFORCEMENT

1. ALL REINFORCEMENT TO BE MANUFACTURED IN ACCORDANCE WITH AS/NZS4671

Z. ALL	REINFORCING SHOULD BE AS PER TABLE BELOW:
SYMBOL	TYPE
D	DEFORMED BARS GRADE 300E TO AS/NZS4671 (300MPa)
R	STRUCTURAL GRADE 300E PLAIN BARS TO AS/NZS4671 (300MPa)
HD	DEFORMED BARS GRADE 500E TO AS/NZS4671 (500MPa)
HR	PLAIN BARS GRADE 500E TO AS/NZS4671 (500MPa)
SE+	SEISMIC GRADE 500E MESH TO AS/NZS 4671 (500MPa)

- TYPICAL REINFORCEMENT DESIGNATIONS ARE AS FOLLOWS:
  4HD12 DENOTES 4No GRADE 500E DEFORMED 12mm DIAMETER BARS
  R6 DENOTES GRADE 300E PLAIN ROUND 6mm DIAMETER
- STIRRUPS REINFORCEMENT BARS ARE PRESENTED DIAGRAMMATICALLY ON THESE DRAWINGS
- AND ARE NOT TO SCALE.

  WHERE LAPS ARE NOT SPECIFICALLY SHOWN BARS MAY BE LAPPED AT RANDOM IN A STAGGERED PATTERN.
- UNLESS OTHERWISE NOTED ON DRAWINGS MINIMUM COVER SHOULD COMPLY
- WITH NZS4210 TABLE 2EI FOR MASONRY DURABILITY.
  UNLESS OTHERWISE NOTED ON DRAWINGS MINIMUM COVER TO PRINCIPLE
  REINFORCEMENT SHALL BE TO THE TABLE BELOW:

REINFORGEMENT STALE BE TO THE TABLE BEEON.					
MAIN REBAR COVER -	MINIMUM mm				
EXPOSURE CLASSIFICATION	INSITU	PRECAST			
INTERIOR SURFACES	30	25			
EXTERIOR SURFACES	50	40			

MINIMUM ITITI	
INSITU	PRECAST
30	25
50	40
75	-
50	-
50	40
	INSITU 30 50 75 50

- REMINDER OF COVERS TO CONFORM TO NZS3101:PART 1:2006
- SPLICE IN REINFORCEMENT SHOULD COMPLY WITH NZS3101.

  UNILESS OTHERWISE NOTED ON DRAWINGS NO REINFORCEMENT SPLICES SHOULD BE MADE OR AS OTHERWISE APPROVED BY THE ENGINEER.

  SPLICE LENGTHS SHALL NOT BE LESS THAN THAT SHOWN IN THE TABLES.
- BELOW UNLESS NOTED OTHERWISE.
- A) HIGH STRENGTH DEFORMED REBARS GRADE 500

BAR	SPLICE LENGTH			
DESIGNATION	f'c = 25MPa	f'c = 30MPa OR GREATER		
HD10	500/650	460/595		
HD12	600/780	550/715		
HD16	800/1040	730/950		

- B) MESH ONE MESH BAR SPACING + 50mm
- 12. UNLESS OTHERWISE NOTED ON DRAWINGS OR APPROVED BY CHARTERED PROFESSIONAL ENGINEER BARS PARTIALLY EMBEDDED IN CONCRETE SHALL NOT BE REBENT ON SITE
- 13. HOOKS LAPS AND BENDS SHALL COMPLY WITH NZS3109.

MAIN	REBAR BI	ENDS	
STEEL GRADE	BAR DIA mm	MINIMUM BEND DIA	
GRADE 300E	6-20	5d	
GRADE 500E	24-32	6d	4d NOT LESS THEN 65mm

STIRRUP & TIE HOOK BENDS - MINIMUM BEND = 135*					
STEEL GRADE	DAD DIA	MINIMUM BE	ND DIAMETER		
STEEL GRADE	BAR DIA mm	PLAIN BARS	DEFORMED BARS		
300E / 500E	6-20	2d	4d		
300E / 500E	24-32	3d	6d		

BL00	CKWORK	REBAR	SPLICE	LENGTHS	5
BAR SIZE	10	12	16	20	25
GRADE 300E	-	550	700	900	1100
GRADE 500E	700	900	1200	1500	1900

- Remove topsoil & grass sods, loose soil pockets and tree slumps. Fill all holes with compacted metal to form a level sub-base.
- Do not scale from drawing, refer t architectural drawings for overall dimensions.
- All setout dimensions & levels to be confirmed on site by contractor prior to construction.
- All plumbing, drainage and central heating pipes to be placed as per location on architectural drawings.
- In case of any discrepancy between architectural drawings and this drawing, Tilsley Engineering Ltd must be contacted immediately and no further works shall be undertaken until the discrepancy is eliminated.
- In case of any unexpected ground conditions, contractor must consult a geotechnical engineer immediately.
- Hardfill to be compacted in layers of 200mm max. Hardfill to be extended 1000mm min beyond perimeter.
- . Where underfloor heating is installed floor topping shall be increased to 110mm.
- . Concrete must be cured using appropriate curing method(s) for a minimum of seven days.
- All concrete strength shall be 20MPa o 25MPa in sea spray zone.
- 11. Polystyrene pods shall be 1100x1100x300 deep.
- 12. If recess floor for shower is required, the polystyrene pods thickness shall be reduced to maintain constant slab thickness. Recesses shall be trimmed with 2HD12 all around.
- 13. Rib—Raft may crack due to various reasons of ambience and construction. This does not affect the structural integrity of the foundations.
- 14. Steel bars cast against and/or exposed to ground shall have 50mm cover. Bars with no DPM in ground shall have 75mm cover. Surface finishes to be in accordance with NZS 3144:1987.
- 16.Reinforcement grades to NZS 4671: HD: Deformed bars grade 500 MPA
- D: Deformed bars grade 300 MPA
- 17. Planting trees should be avoided near the foundation, and must be kept a distance of 1.5 x the mature height of the tree from the

Job N	0.	16125	
Drawn	Ву	Z.H	
Desig	ned By	Z.H.	
Approved By		A.G.	
No.		Revision/Issue	Date

# TILSLEY ENGINEERING LTD



27 Roulston street Pukekohe PO Box 392 Tel: 09 238 3245 info@teng.co.nz

Project Name and Address

Podfloor Foundation Waikare Estate Limited

6 Rylstone Way Te Kauwhata

Foundation Details	Sileet
Date 30.04.2021	502
Scale As Shown	

# NOTE: CONTRACTOR SHALL CONFIRM DATUM SOURCE ON SITE PLAN BEFORE COMMENCING CONSTRUCTION

CONTRACTOR SHALL VERIFY ALL DIMENSIONS ON SITE BEFORE COMMENCING CONSTRUCTION. WRITTEN DIMENSIONS SUPERSEDE SCALED DIMENSIONS. REFER TO SPECIFICATIONS FOR RELEVANT TRADE CODES/REFERENCE DOCUMENTS WHICH FORM PART OF THIS CONTRACT.

REV NO. REVISION:

BY: DATE: franklin rchitectural design PO Box 11019, Palm Beach 3118


Find us at www.franklinarchitectural.co.nz

PROPOSED RESIDENCE **Waikare Estate Limited 6 RYLSTONE WAY, TE KAUWHATA** 

DRAWING TITLE

**FOUNDATION DETAILS** 


DRAWN	KBR	DRAWING NUMBER
CHECKED	KB	08
PROJECT NUMBER:	21 3710	SCALE
REVISION:	WD01	N.T.S
PLOT DATE	19/05/2021	

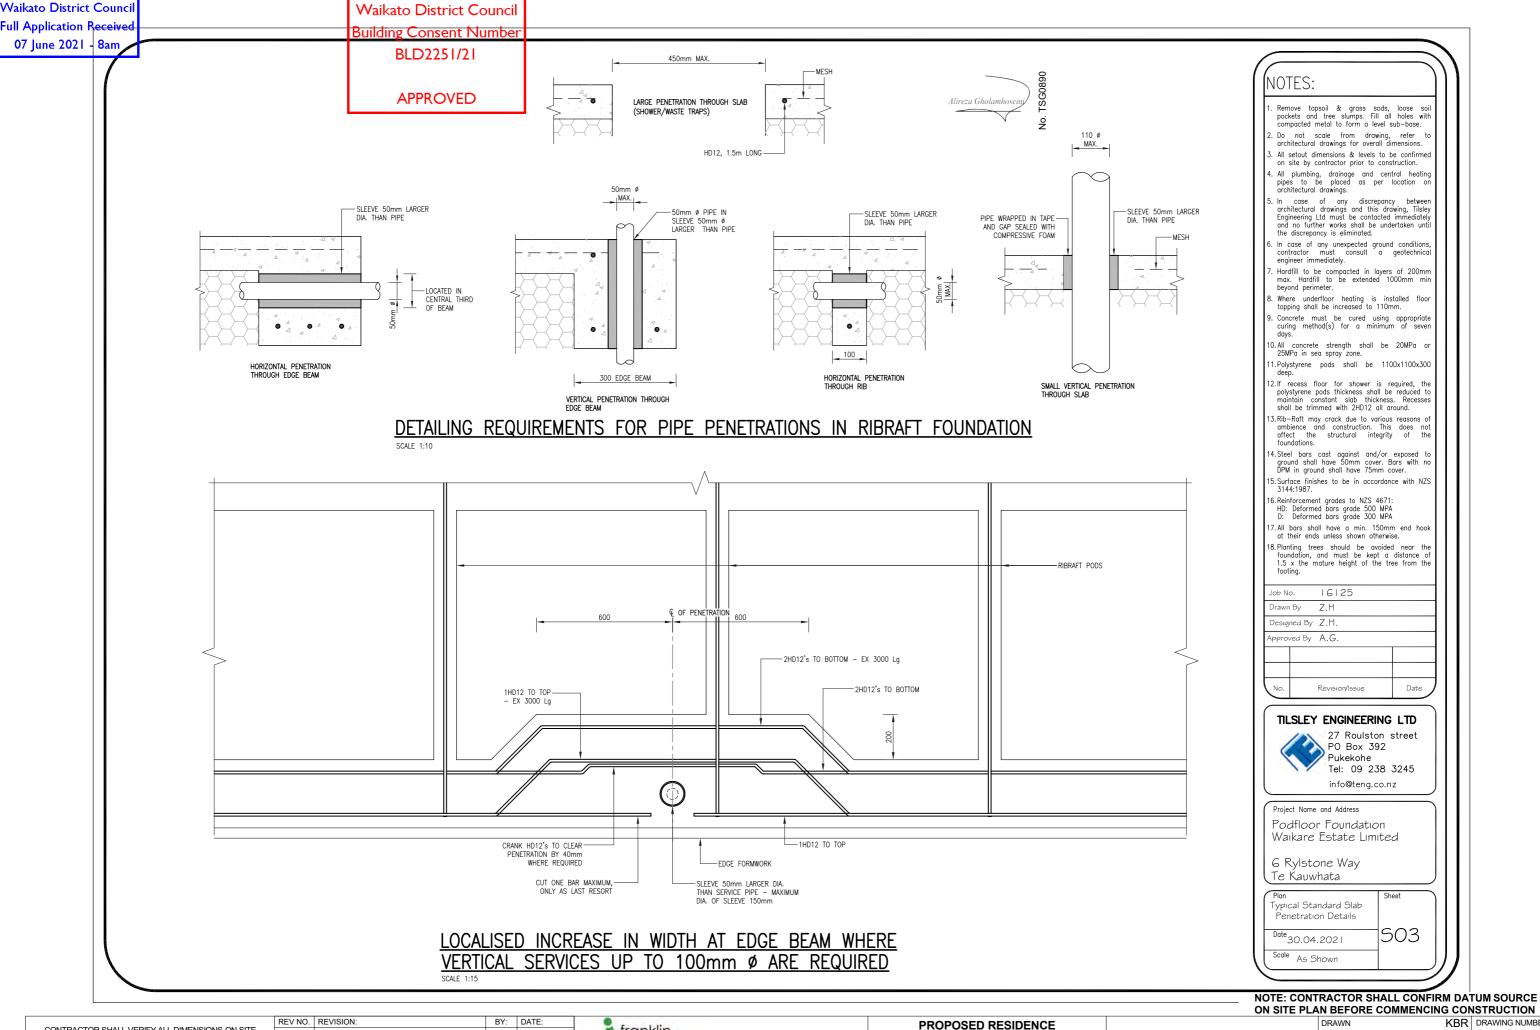


CONTRACTOR SHALL VERIFY ALL DIMENSIONS ON SITE franklin 09 BEFORE COMMENCING CONSTRUCTION.
WRITTEN DIMENSIONS SUPERSEDE SCALED DIMENSIONS. CHECKED KΒ DRAWING TITLE rchitectural Find us at SCALE **Waikare Estate Limited** PROJECT NUMBER: 21 3710 REFER TO SPECIFICATIONS FOR RELEVANT TRADE CODES/REFERENCE DOCUMENTS WHICH FORM PART OF THIS design www.franklinarchitectural.co.nz **FOUNDATION DETAILS** REVISION: WD01 N.T.S PO Box 11019, Palm Beach 3118 CONTRACT. **6 RYLSTONE WAY, TE KAUWHATA** PLOT DATE 19/05/2021

Waikato District Counci

Document Set ID: 3154607 Version: 1, Version Date: 21/06/2021

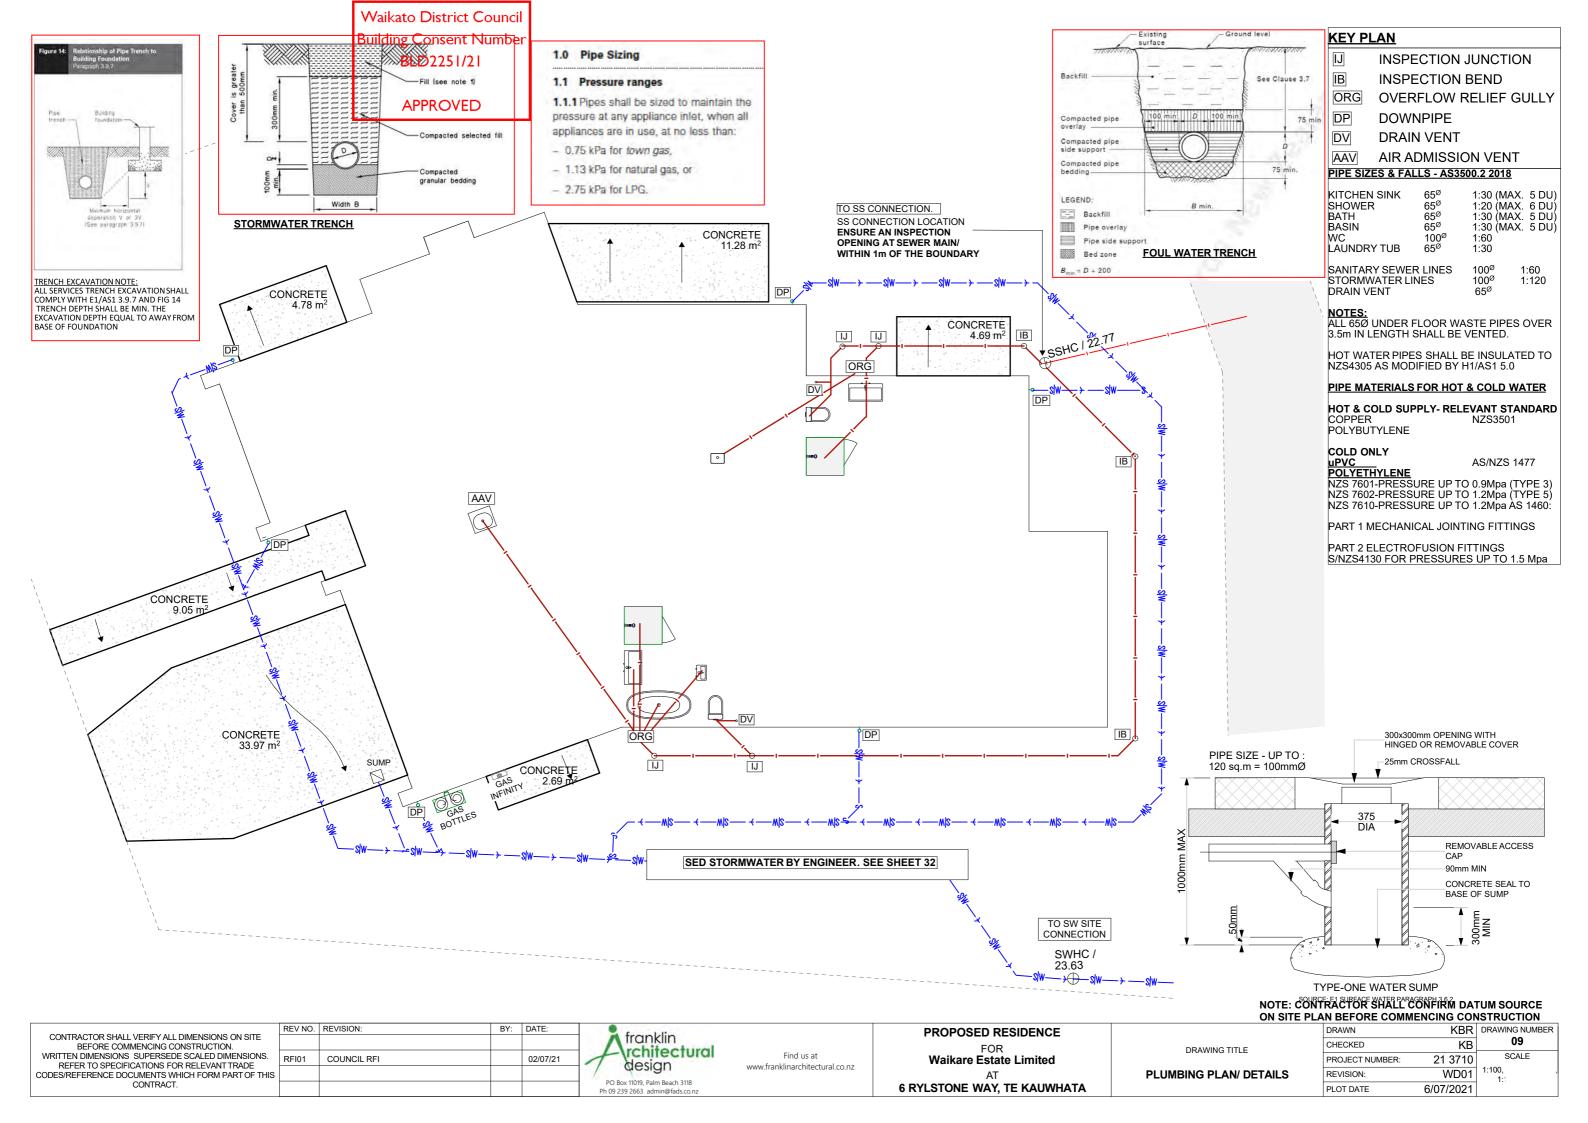

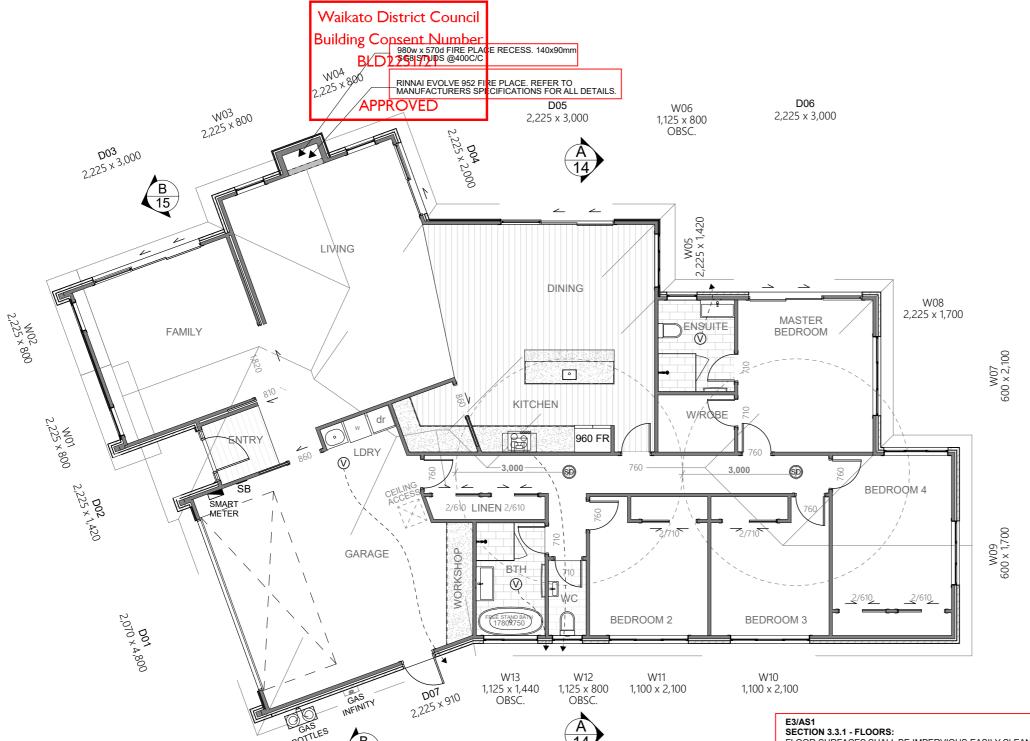

FLOORING MEASUREMENTS

VINYL PLANKING

3.89 m<sup>2</sup> SHOWER TILES

31.05 m

4.42 m

**ENTRY** 

KITCHEN

DINING

ENSUITE

BATHROOM

**ELEVATION KEY NOTES** 

E01

E04

E02

F.F.L. = 24.50m

FLOOR AREA OA FRAME (m<sup>2</sup>): 228.22 FLOOR AREA OA BRICK (m2):

CEILING HEIGHT = 2.42m

WINDOW/DOOR HEAD HEIGHTS: 2.225m (TO SOFFIT)

INTERNAL DOOR HEIGHT: 2.0m

SMOKE DETECTORS:

MAX. 3m FROM BEDROOM DOORS

MECHANICAL VENTILATION: (V)

MECHANICAL VENTILATION TO BE DUCTED TO OUTSIDE VIA SOFFIT (SHELTERED). NOTE: MECHANICAL VENTILATION FLOW RATE TO COMPLY WITH G4/AS1 1.2.5:

MIN 50L/s FOR COOKTOPS

MIN 25L/s FOR SHOWERS AND BATHS

FLOOR FINISHES KEY	
SLIP RESISTANCE - MAIN ENTRY PATH BROOMED (CLASS 5 OR 6)(6) OR WOOD FLOAT FINISH (CLASS U2)	
CARPET	
VINYL FLOORING	
ARDEX WATERPROOFING WPM 002 SUPERFLEX BATHROOM AND BALCONY MEMBRANE SYSTEM & FLOOR TILING SYSTEM SHALL BE PROVIDED TO ALL WET AREAS BELOW FLOOR OVERLAYS INSTALLED TO MANUFACTURERS REQUIREMENTS BY AN APPROVED INSTALLER, REFER SPECIFICATIONS.	

ARTIFICIAL LIGHTING COMPLYING WITH NZBC G8 SHALL BE PROVIDED ALONG ACCESS MAIN ROUTE

FLOOR SURFACES SHALL BE IMPERVIOUS EASILY CLEANED IN SPACES CONTAINING SANITARY FIXTURES OR APPLIANCES AND EXTEND MINIMUM 1.5m FROM ALL SANITARY FIXTURES AND APPLIANCES

- ALL INTEGRALLY WATERPROOF SHEET MATERIAL (e.g. POLYVINYLCHLORIDE) WITH SEALED JOINTS AND SEALED OR COVED AT EDGES WHERE WATER SPLASH MAY

- CERAMIC OR STONE TILES WITH 6% MAX. WATER ABSORPTION, WATERPROOF GROUTED JOINTS AND BEDDED WITH AN ADHESIVE SPECIFIED BY THE TIME MANUFACTURER AS BEING SUITABLE FOR THE TILES, SUBSTRATE MATERIAL, AND THE ENVIRONMENT OF USE. - SLAB ON GRADE CONCRETE FLOOR HAVING A STEEL TROWEL OR POLISHED FINISH, SEALED AT EDGES WHERE WATER SPLASH MAY OCCUR, WHEN USED IN A DOMESTIC LAUNDRY WITHIN A GARAGE.

# SECTION 3.1.2 - WALLS:

WALLS SHALL SATISFY THE PERFORMANCE FOR IMPERVIOUS AND EASILY CLEANED SURFACES IN AREAS ADJACENT TO SANITARY FIXTURES OR SANITARY APPLIANCES OR OTHERWISE LIKELY TO BE SPLASHED IN THE COURSE OF THE INTENDED USE OF THE BUILDING.

- INTEGRALLY WATERPROOF SHEET ( e.g. POLYVINYLCHLORIDE) WITH SEALED JOINTS.

CERAMIC OR STONE TILES WITH 6% MAX. WATER ABSORPTION, WATERPROOF GROUTED JOINTS AND BEDDED WITH AN ADHESIVE SPECIFIED BY THE TIME MANUFACTURER AS BEING SUITABLE FOR THE TILES, SUBSTRATE MATERIAL, AND THE ENVIRONMENT OF USE. - SHEET LININGS WITH A SEMIGLOSS OR GLOSS COATING OR A HARD-WEARING LOW-SHEEN LATEX PAINT CONTAINING MOULD INHIBITORS.

- WATER-RESISTANT SHEET LININGS FINISHED WITH DECORATIVE HIGH-PRESSURE LAMINATE OR FACTORY-APPLIED POLYURETHANE OR RESIN AND INSTALLED WITH IMPERVIOUS JOINTS

SECTION 3.2.1- JOINTS TO FLOORS:
JOINTS BETWEEN FIXTURES AND IMPERVIOUS FLOOR FINISHES


WHERE SANITARY FIXTURES ABUT IMPERVIOUS FLOOR FINISHES, THE BASE OF THE FIXTURE MUST BE SEALED TO THE IMPERVIOUS FLOOR FINISH.

# SECTION 3.2.2-JOINTS TO WALLS

JOINTS BETWEEN FIXTURES AND WALL LININGS WHERE BATHS, BASINS, TUBS, OR SINKS ABUT IMPERVIOUS LININGS, THE JOINT BETWEEN FIXTURE AND LINING SHALL BE SEALED TO PREVENT WATER PENETRATION TO CONCEALED SPACES OR BEHIND LININGS.

> NOTE: CONTRACTOR SHALL CONFIRM DATUM SOURCE ON SITE PLAN BEFORE COMMENCING CONSTRUCTION

CONTRACTOR CHALL VERIEVALL RIMENCIONO ON OUT	REV NO	. REVISION:	BY:	DATE:	Energiation		PROPOSED RESIDENCE		DRAWN	KBR	DRAWING NUMBER
CONTRACTOR SHALL VERIFY ALL DIMENSIONS ON SITE BEFORE COMMENCING CONSTRUCTION.					franklin		FOR	DRAWING TITLE	CHECKED	KB	10
WRITTEN DIMENSIONS SUPERSEDE SCALED DIMENSIONS. REFER TO SPECIFICATIONS FOR RELEVANT TRADE	RFI01	COUNCIL RFI		02/07/21	rchitectural	Find us at	Waikare Estate Limited	DIAWING TITEL	PROJECT NUMBER:	21 3710	SCALE
CODES/REFERENCE DOCUMENTS WHICH FORM PART OF THIS					design	www.franklinarchitectural.co.nz	AT	FLOOR PLAN	REVISION:	WD01	1:100.
CONTRACT.					PO Box 11019, Palm Beach 3118 Ph 09 239 2663 admin@fads.co.nz		6 RYLSTONE WAY, TE KAUWHATA		PLOT DATE	6/07/2021	1.100,

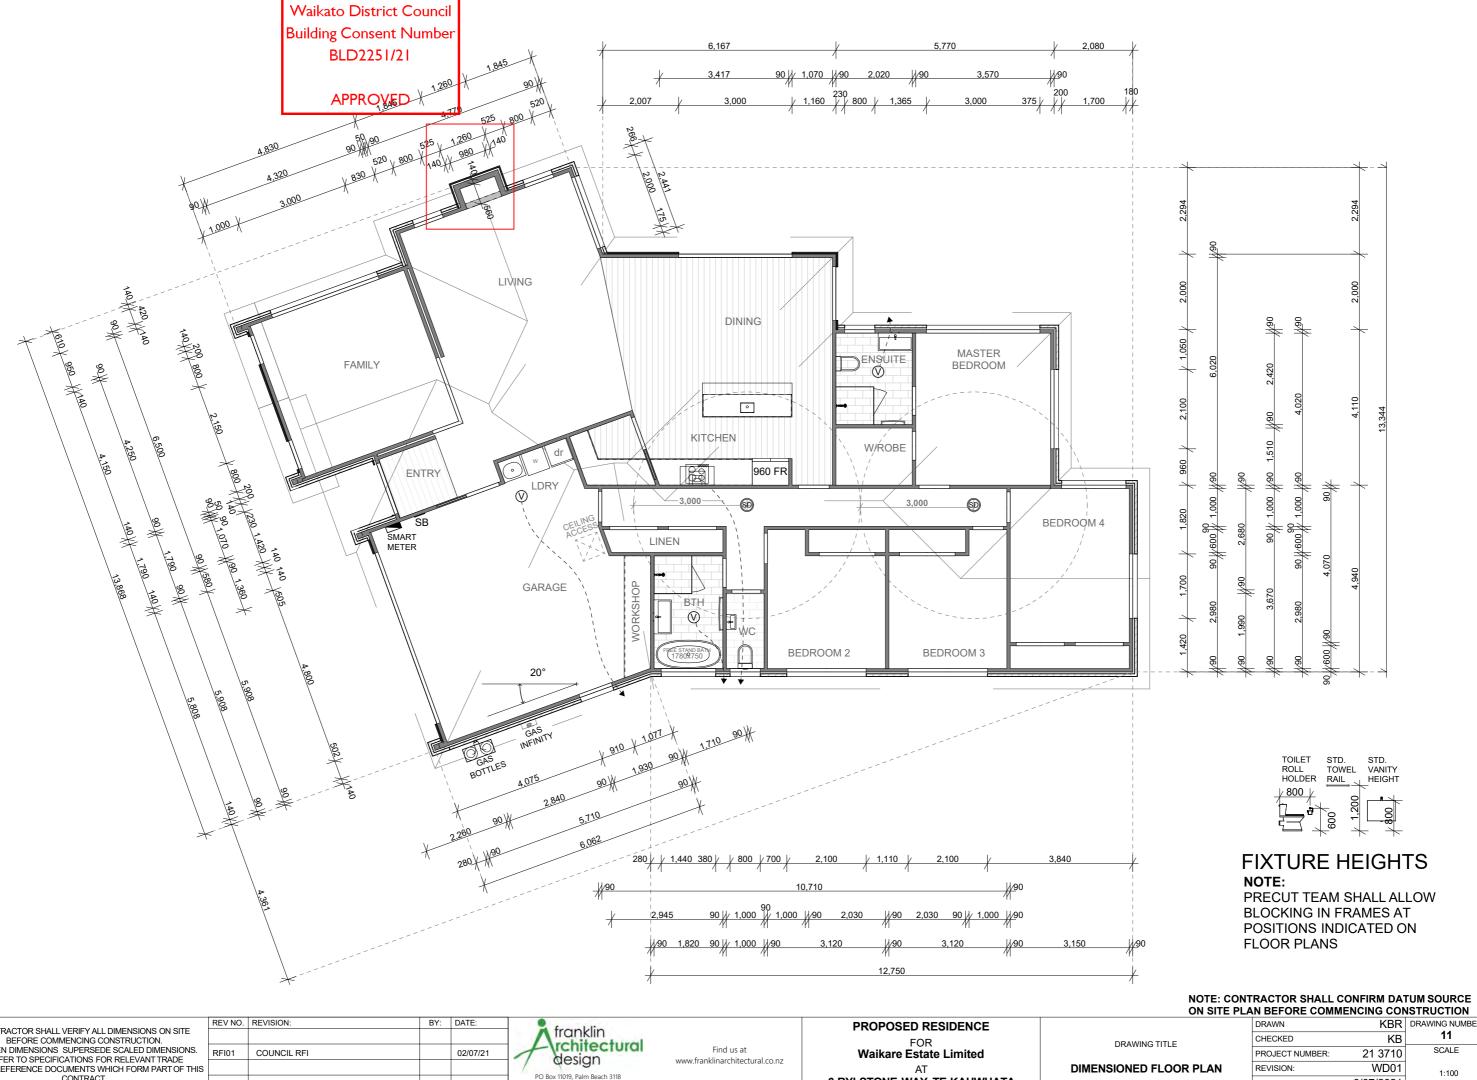


CONTRACTOR SHALL VERIFY ALL DIMENSIONS ON SITE
BEFORE COMMENCING CONSTRUCTION.
WRITTEN DIMENSIONS SUPERSEDE SCALED DIMENSIONS.
REFER TO SPECIFICATIONS FOR RELEVANT TRADE
CODES/REFERENCE DOCUMENTS WHICH FORM PART OF THIS CONTRACT.

PO Box 11019, Palm Beach 3118 Ph 09 239 2663 admin@fads.co.r

6 RYLSTONE WAY, TE KAUWHATA

DRAWN	KBR	DRAWING NUMBER
CHECKED	KB	11
PROJECT NUMBER:	21 3710	SCALE
REVISION:	WD01	1:100
PLOT DATE	6/07/2021	



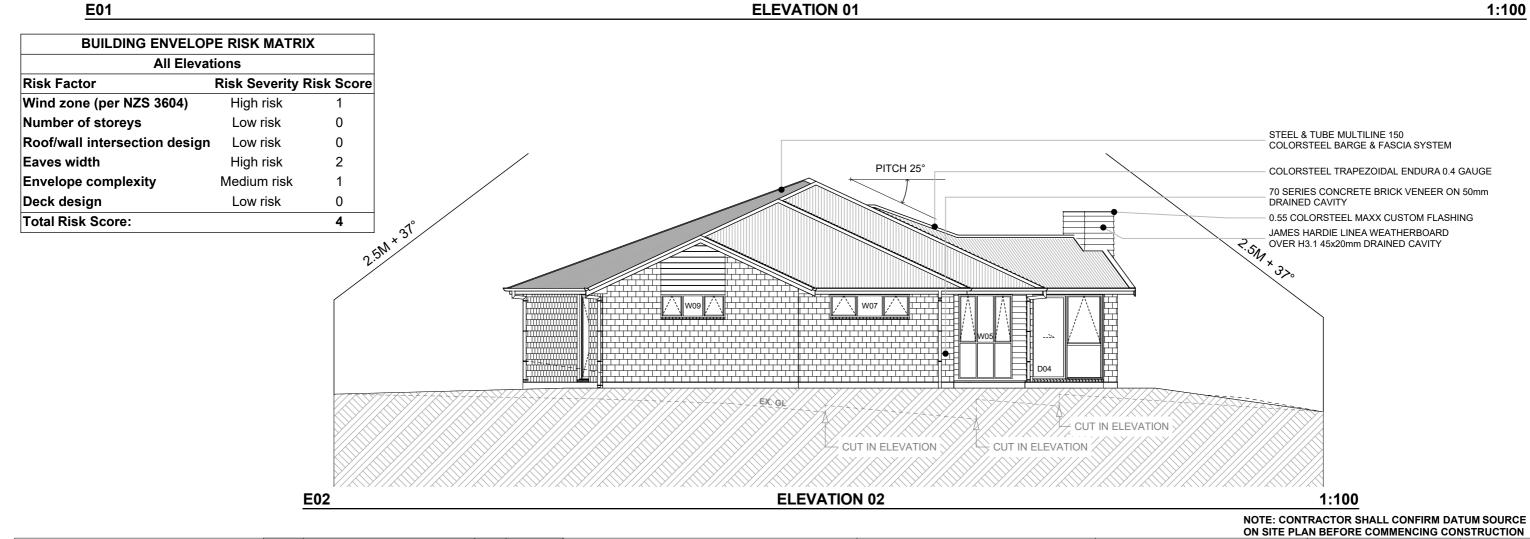

Find us at

www.franklinarchitectural.co.nz

franklin rchitectural

design

PO Box 11019, Palm Beach 3118 Ph 09 239 2663 admin@fads.co.r

Document Set ID: 3154607

Version: 1, Version Date: 21/06/2021

CONTRACTOR SHALL VERIFY ALL DIMENSIONS ON SITE
BEFORE COMMENCING CONSTRUCTION.
WRITTEN DIMENSIONS SUPERSEDE SCALED DIMENSIONS.
REFER TO SPECIFICATIONS FOR RELEVANT TRADE
CODES/REFERENCE DOCUMENTS WHICH FORM PART OF THIS

REV NO. REVISION:

PROPOSED RESIDENCE

ON SITE PLAN BEFORE COMMENCING CONSTRUCTION

DRAWN
KBR DRAWNING NUMBER
DRAWN KBR DRAWNING NUMBER

FOR
Waikare Estate Limited
AT
6 RYLSTONE WAY, TE KAUWHATA

DRAWING TITLE

ELEVATIONS E01 & E02


 DRAWN
 KBR
 DRAWING NUMBER

 CHECKED
 KB
 13

 PROJECT NUMBER:
 21 3710
 SCALE

 REVISION:
 WD01

 PLOT DATE
 19/05/2021

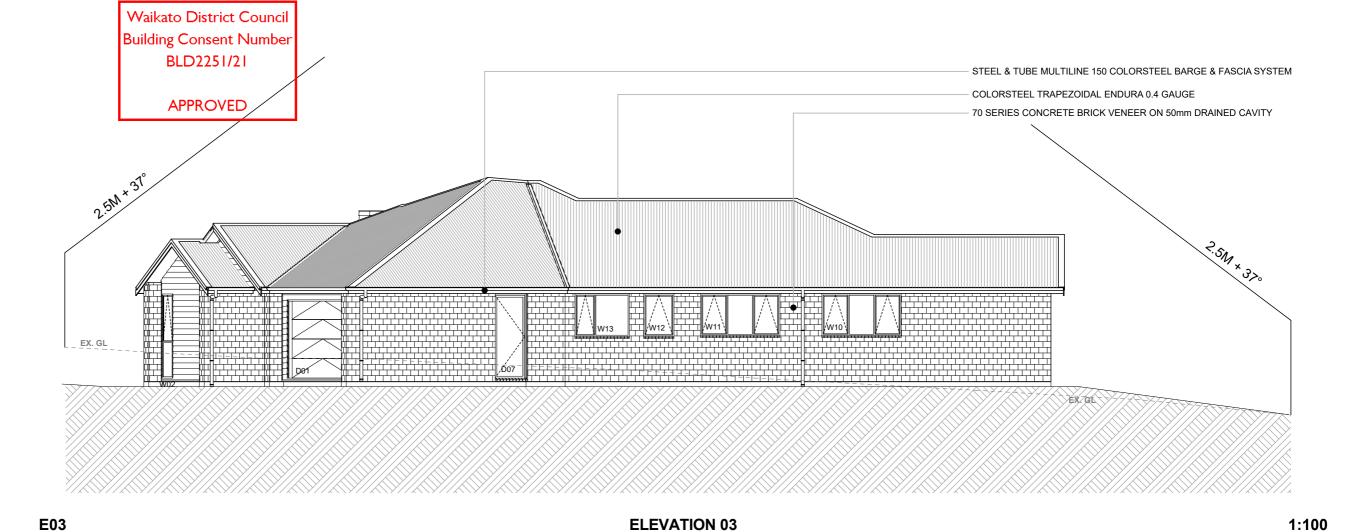



**BUILDING ENVELOPE RISK MATRIX All Elevations** Risk Factor Risk Severity Risk Score Wind zone (per NZS 3604) High risk Number of storeys Low risk 0 0 Roof/wall intersection design Low risk 2 Eaves width High risk Medium risk Envelope complexity 1 Deck design Low risk 0 Total Risk Score: 4



FLAT SOFFIT TO ENTRY

20° DIFFERENTIATION FROM OTHER ELEVATIONS TO ACCOMODATE THE CHANGE IN ANGLE OF THE HOUSE


E04 ELEVATION 04 1:100

# NOTE: CONTRACTOR SHALL CONFIRM DATUM SOURCE ON SITE PLAN BEFORE COMMENCING CONSTRUCTION

	CONTRACTOR SHALL VERIFY ALL DIMENSIONS ON SITE	REV NO. REVISION:	BY: DATE:	fu avalelia		PROPOSED RESIDENCE		DRAWN	KBR	DRAWING NUMBER
	BEFORE COMMENCING CONSTRUCTION.			Irankiin		FOR	DRAWING TITLE	CHECKED	KB	14
	WRITTEN DIMENSIONS SUPERSEDE SCALED DIMENSIONS. REFER TO SPECIFICATIONS FOR RELEVANT TRADE			design	Find us at	Waikare Estate Limited	DIAWING TITLE	PROJECT NUMBER:	21 3710	SCALE
1	CODES/REFERENCE DOCUMENTS WHICH FORM PART OF THIS			design	www.franklinarchitectural.co.nz	AT	<b>ELEVATIONS E03 &amp; E04</b>	REVISION:	WD01	1:100
D-	CONTRACT.			PO Box 11019, Palm Beach 3118 Ph 09 239 2663 admin@fads.co.nz		6 RYLSTONE WAY, TE KAUWHATA		PLOT DATE	19/05/2021	1.100

PITCH 25°

Waikato District Council
Building Consent Number
BLD2251/21
APPROVED

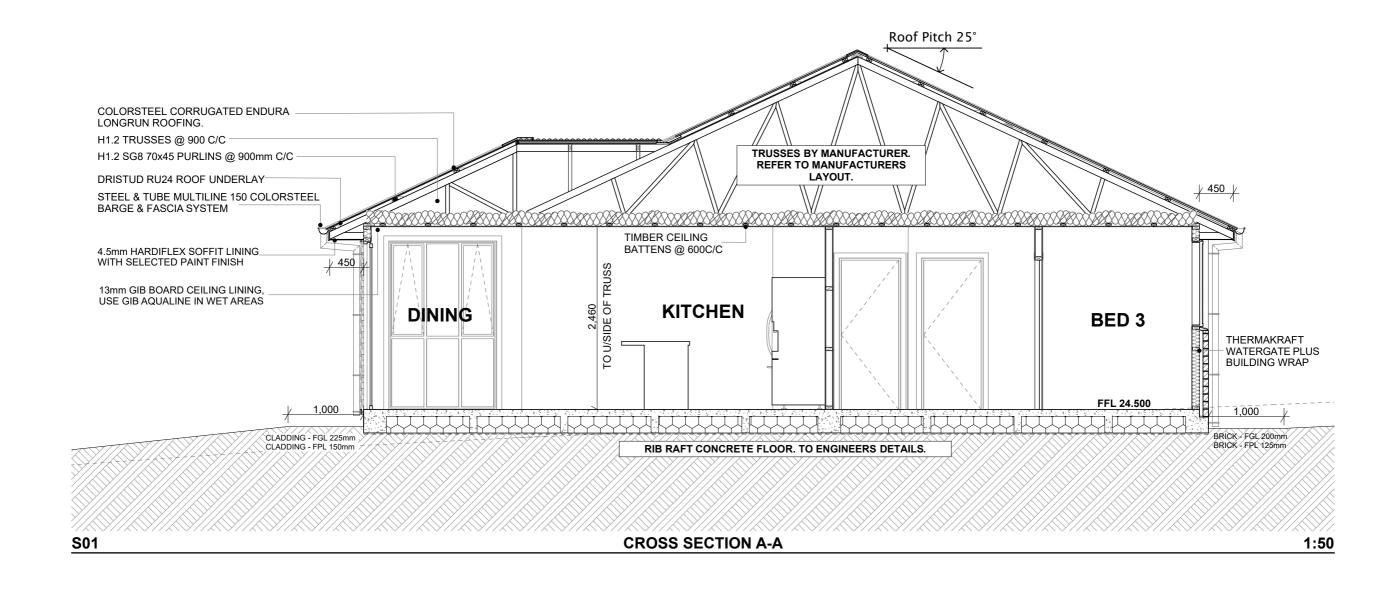


# NOTE: CONTRACTOR SHALL CONFIRM DATUM SOURCE ON SITE PLAN BEFORE COMMENCING CONSTRUCTION

CONTRACTOR SHALL VERIFY ALL DIMENSIONS ON SITE	REV NO.	REVISION:	BY: DATE:	_	franklin		PROPOSED RESIDENCE		DRAWN	KBR D	RAWING NUMBER
BEFORE COMMENCING CONSTRUCTION.					Architectural		FOR	DRAWING TITLE	CHECKED	KB	15
WRITTEN DIMENSIONS SUPERSEDE SCALED DIMENSIONS. REFER TO SPECIFICATIONS FOR RELEVANT TRADE				1	design	Find us at	Waikare Estate Limited	DIGWING THEE	PROJECT NUMBER:	21 3710	SCALE
CODES/REFERENCE DOCUMENTS WHICH FORM PART OF THIS				/		www.franklinarchitectural.co.nz	AT	CROSS SECTION A-A	REVISION:	WD01	1:50
CONTRACT.				PI	PO Box 11019, Palm Beach 3118 Ph 09 239 2663 admin@fads.co.nz		6 RYLSTONE WAY, TE KAUWHATA		PLOT DATE	19/05/2021	1.00


Waikato District Council Building Consent Number BLD2251/21

**APPROVED** 

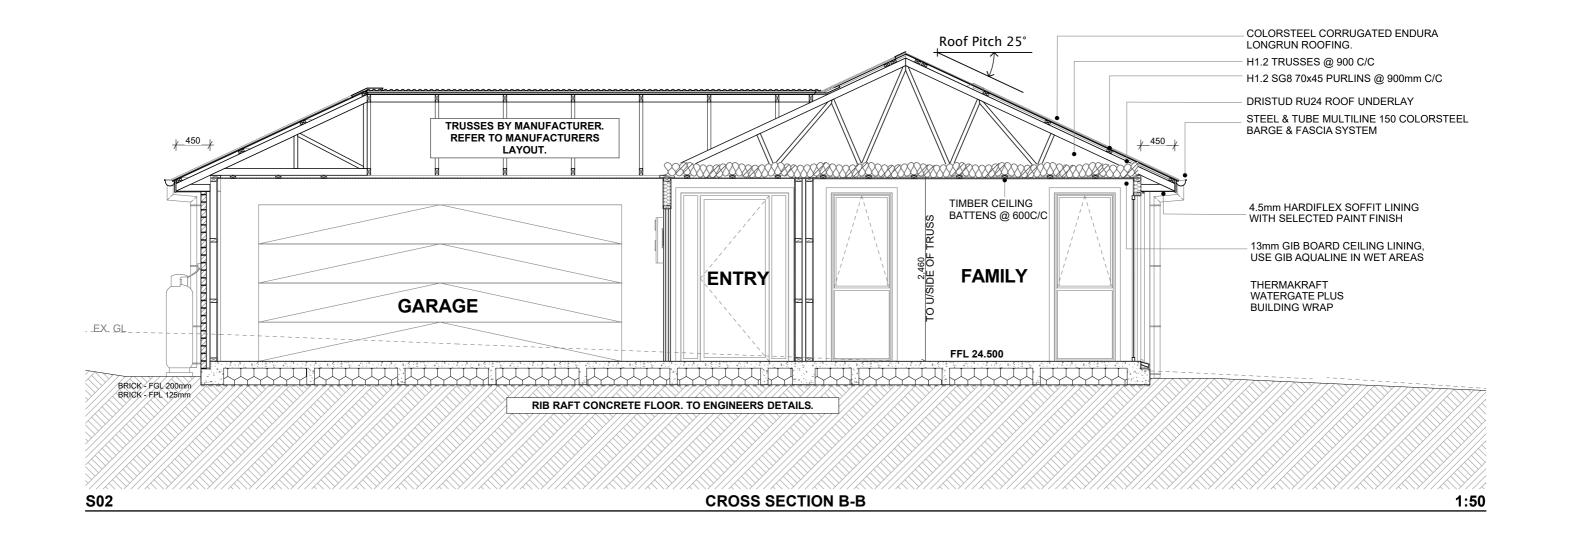

# NOTE: CONTRACTOR SHALL CONFIRM DATUM SOURCE ON SITE PLAN BEFORE COMMENCING CONSTRUCTION

	REV NO	.   REVISION:	BY:   DATE:			PROPOSED RESIDENCE		DRAWN	KBR I	DRAWING NUMBER
CONTRACTOR SHALL VERIFY ALL DIMENSIONS ON SITE				n tranklin		I NOI GOLD INCOIDENCE				16
BEFORE COMMENCING CONSTRUCTION.				( vahita atuval		FOR	DRAWING TITLE	CHECKED	KB	10
WRITTEN DIMENSIONS SUPERSEDE SCALED DIMENSIONS.				\rcnitectural	Find us at	Waikare Estate Limited	DIAWING TITLE	PROJECT NUMBER:	21 3710	SCALE
REFER TO SPECIFICATIONS FOR RELEVANT TRADE				design	www.franklinarchitectural.co.nz	Walkare Estate Littliteu		PROJECT NUMBER.	21 37 10	
CODES/REFERENCE DOCUMENTS WHICH FORM PART OF THIS				design	www.mankimarchitectural.co.nz	ΔΤ	CROSS SECTION B-B	REVISION:	WD01	
CONTRACT.				PO Box 11019, Palm Beach 3118		711				1:50
				Ph 09 239 2663 admin@fads.co.nz		6 RYLSTONE WAY, TE KAUWHATA		PLOT DATE	19/05/2021	
Document Set ID: 3154607				THOSESS ESOS GATTING IGASCOTTE		,				

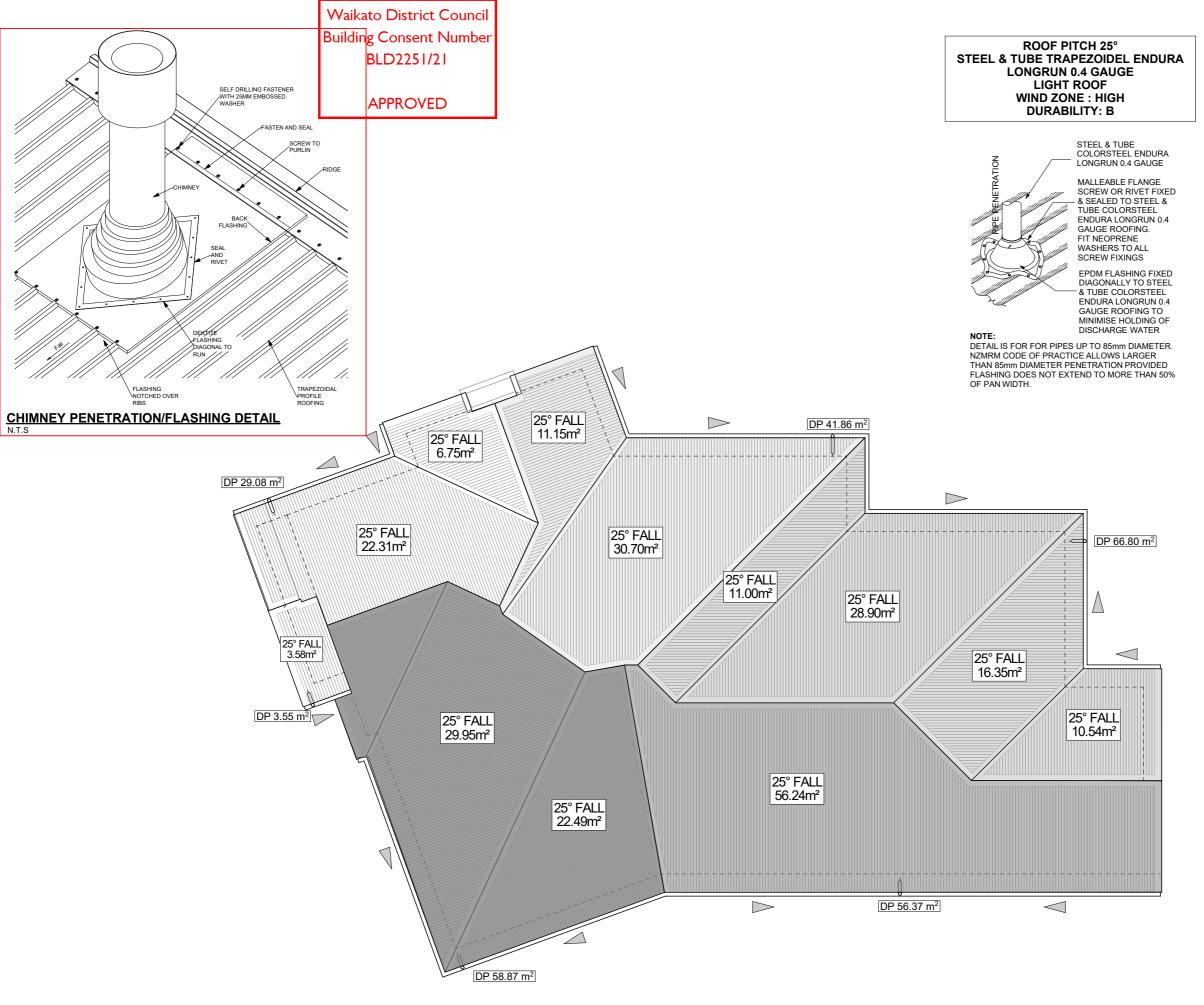

DP

<

80Ø COLORSTEEL DOWNPIPE 0-25° - 100m<sup>2</sup> PER DP BASED ON 100mm RAIN HR.

----OUTSIDE LINE OF BUILDING BELOW

FALL OF GUTTER TOWARDS DP

**KEY PLAN** 

# HIGH WIND ZONES, WHERE ROOF PITCH IS 10° OR **GREATER**

ROOF CLADDINGS SHALL MEET REQUIREMENTS OF NZBC E2.2, TABLE 7 AND CONSTRUCTED TO PARAGRAPH 8.1.2 TO PARAGRAPH 8.5

**GUTTERS SHALL COMPLY WITH E1/AS1.** WHERE GUTTER DEPTH IS REDUCED TO ALLOW VALLEY GUTTER ENTRY REDUCED DEPTH SHALL BE USED TO CALCULATE GUTTER CAPACITY

# **METAL FLASHINGS - GENERAL DIMENSIONS**

SEE NOTES BELOW

**RIDGES** 

TRANSVERSE FLASHING **OVER ROOFING** 

REFER TO APRONS: **GENERAL** 

**BARGES** 

**WINDOWS** 

OVERLAP TO BARGE BOARD

50mm EXCL DRIP EDGE

WINDOW FLANGE CLEARANCE

5mm

COVER TO WINDOW/DOOR

FOR CLADDINGS ON CAVITIES

10mm min

COVER TO WINDOW/DOOR

8mm min.

SILL FLANGE

JAMB FLANGE

**SILLS** 

SILL FLASHING SLOPE

FLAT

**HEADS** 

HEAD FLASHING SLOPE

15° min.

LAP UNDER CLADDING ABOVE

35mm min 5mm

ANTICAPILLARY GAP TO CLADDING

**TOTAL UPSTAND** 

40mm min.

**CORNERS** 

**CORNER FLASHING** 

50x50mm min.

DIMENSIONS APPLY UNLESS OTHERWISE DIMENSIONED IN DETAILS

DIMENSIONS EXCLUDE ANY SOFT EDGE OR TURN DOWN TO ROOFING.

NOTE: CONTRACTOR SHALL CONFIRM DATUM SOURCE ON SITE PLAN BEFORE COMMENCING CONSTRUCTION

CONTRACTOR SHALL VERIFY ALL DIMENSIONS ON SITE BEFORE COMMENCING CONSTRUCTION.
WRITTEN DIMENSIONS SUPERSEDE SCALED DIMENSIONS. REFER TO SPECIFICATIONS FOR RELEVANT TRADE CODES/REFERENCE DOCUMENTS WHICH FORM PART OF THIS CONTRACT.

REV NO. REVISION: BY: DATE: franklin rchitectural RFI01 COUNCIL RFI 02/07/21 design PO Box 11019, Palm Beach 3118

Find us at www.franklinarchitectural.co.nz


PROPOSED RESIDENCE **Waikare Estate Limited 6 RYLSTONE WAY, TE KAUWHATA** 

DRAWING TITLE **ROOF LAYOUT PLAN** 

 IN DEI ONE COMMI	-1401140 001	101110011011
DRAWN	KBR	DRAWING NUMBER
CHECKED	KB	16
PROJECT NUMBER:	21 3710	SCALE
REVISION:	WD01	1:100
PLOT DATE	6/07/2021	

# Waikato District Council Waikato District Council Full Application Received **Building Consent Number** 07 June 2021 - 8am **FASTENING LAYOUT SHALL BE:** 450 BLD2251/21 C3 FASTENING PATTERN - 3 PER SHEET HIT 1, MISS 2, MISS 3... IN ACCORDANCE WITH NZ METAL ROOF AND WALL CLADDING PROVED CODE OF PRACTICE v3.0 Standard Corrugate minimum 16.5 mm high, G550 Steel, 0.40mm BM7 450// NZS 3604 SLS Design Wind Zone Load 450 1.72 kPa 1.32 kPa 0.93 kPa 2.425m CEILING: 220.84 m<sup>2</sup> C3 -C4 - C2 -450<sub>/</sub> / ROOF PLANE PLAN AREA: 255.17 m<sup>2</sup> COLORSTEEL TRAPEZOIDAL ENDURA 0.4 GAUGE UNDERLAY **GUTTER WIDTH 250 MIN** COLORSTEEL TRAPEZOIDAL ENDURA 0.4 GAUGE MULTILINE QUAD SPOUTING COLOUR MATCH SOFT EDGE AT EAVES FASTEN AT EVERY SECOND CORRUGATION PRIOR TO INSTALLATION STEEL & TUBE PLUMBDEK PROFILE ROOFING STANDARD SOFT EDGED RIDGING MIN. COVER 2 CORRUGATIONS UNDERLAY -TURN UP TROUGHS TOP CHORD UNDERLAY HARDIFLEX STEEL & TUBE PLUMBDEK PROFILE ROOFING EX 150x25 H1.2 VALLEY BOARD TRUSS CHORD PURI IN/OUTRIGGER VALLEY PURLIN VALLEY ANGLES & CATCHMENTS -UNDERLAY HIP FLASHING ROOF PITCH 25° -150 MULTILINE FASCIA ROOF PITCH 25° **HIP DETAIL EAVES/GUTTER DETAIL** DIMENSION X 150 **BARGE DETAIL** VALLEY ANGLE **VALLEY DETAIL**

**ROOF PITCH 25°** STEEL & TUBE TRAPEZOIDEL ENDURA LONGRUN 0.4 GAUGE LIGHT ROOF WIND ZONE: HIGH **DURABILITY: C** 

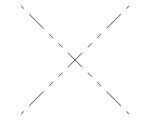

# **ROOF PLANE DIAGONAL BRACE**

ROOF PLANE DIAGONAL BRACE A PAIR OF TENSIONED & CROSSED LUMBERLOK STRIP BRACE OVER TOP CHORDS/RAFTERS INSTALLED AT 45° ± 5° TO THE RAFTER OR PURLIN LINE

# ROOF FRAMING & FIXING INFORMATION: NZS 3604:2011

OUTRIGGERS MIN. 90X45 @ 900CRS. OUTRIGGERS EXTEND BEYOND THEIR SUPPORTS 600MM MAX. FLYRAFTERS: MIN 90X45 FIXED TO OUTRIGGER ENDS, BLOCKING SIZE SHALL MATCH OUTRIGGER SIZE. PURLINS SHALL BE FIXED TO BLOCKING PIECES/FLYRAFTERS OUTRIGGERS SHALL BE FIXED AS FOR PURLIN FIXINGS


TRUSSES -H1.2 SG 8 @ 900mm C/C

# LONGRUN: REFER TABLE 10.10:

- H1.2 SG8 70X45 PURLINS ON THEIR FLATS @ 900mm C/C

# PURLIN FIXINGS SHALL BE:

- T: 1/10G SELF DRILLING SCREW,80mm LONG (OR 5.5KN ALTERNATIVE)

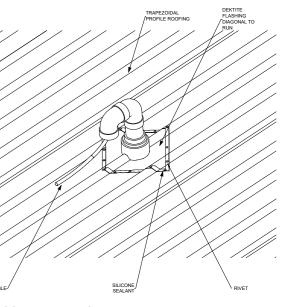


**ROOF PENETRATION DETAIL** 

MAXIMUM CATCHMENT 43m<sup>2</sup>

NOTE: CONTRACTOR SHALL CONFIRM DATUM SOURCE ON SITE PLAN BEFORE COMMENCING CONSTRUCTION

REV NO. REVISION: BY: DATE: KBR PROPOSED RESIDENCE CONTRACTOR SHALL VERIFY ALL DIMENSIONS ON SITE BEFORE COMMENCING CONSTRUCTION. WRITTEN DIMENSIONS SUPERSEDE SCALED DIMENSIONS. franklin 18 CHECKED KΒ DRAWING TITLE rchitectural Find us at SCALE **Waikare Estate Limited** PROJECT NUMBER: 21 3710 REFER TO SPECIFICATIONS FOR RELEVANT TRADE CODES/REFERENCE DOCUMENTS WHICH FORM PART OF THIS design www.franklinarchitectural.co.nz **ROOF FRAMING & SETOUT PLAN** REVISION: WD01 1:100, 1:10 PO Box 11019, Palm Beach 3118 CONTRACT. **6 RYLSTONE WAY, TE KAUWHATA** PLOT DATE 19/05/2021

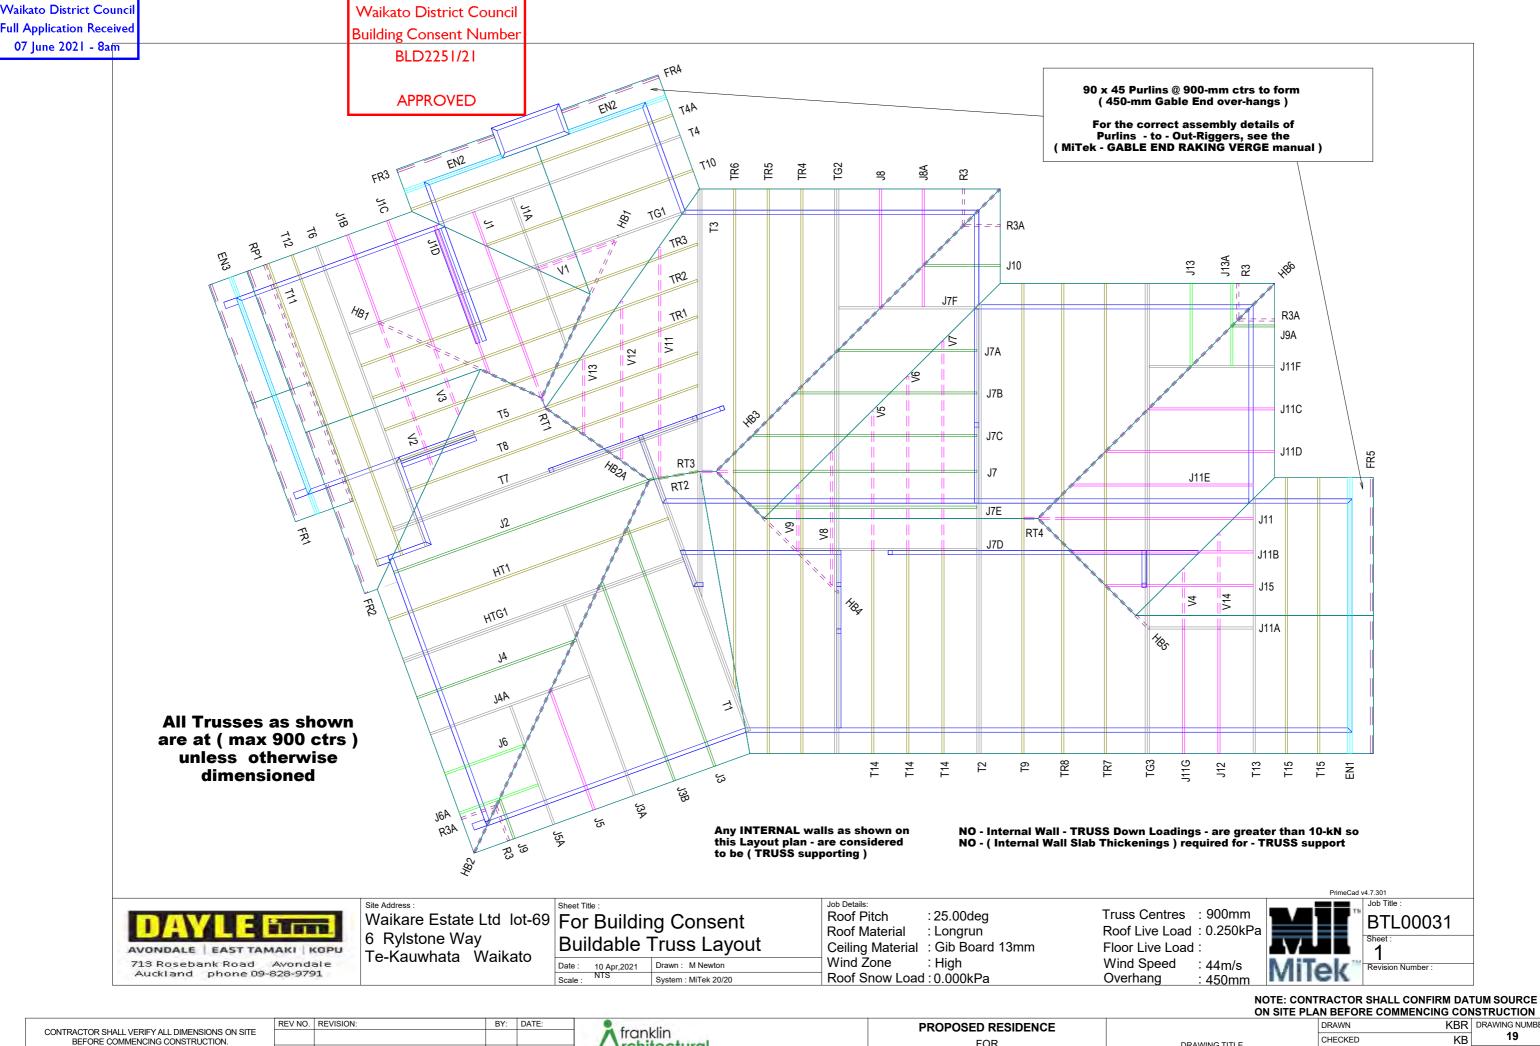

CONTRACTOR SHALL VERIFY ALL DIMENSIONS ON SITE
BEFORE COMMENCING CONSTRUCTION.
WRITTEN DIMENSIONS SUPERSEDE SCALED DIMENSIONS.
REFER TO SPECIFICATIONS FOR RELEVANT TRADE
CODES/REFERENCE DOCUMENTS WHICH FORM PART OF THIS 19 DRAWING TITLE rchitectural Find us at SCALE **Waikare Estate Limited** PROJECT NUMBER: 21 3710 design www.franklinarchitectural.co.nz **BUILDABLE TRUSS LAYOUT** REVISION: WD01 PO Box 11019, Palm Beach 3118 6 RYLSTONE WAY, TE KAUWHATA PLOT DATE 19/05/2021 Document Set ID: 3154607

Waikato District Council **Building Consent Number** 

BLD2251/21

# **Truss Fixings**

APPROVED



X - LUMBERLOK JH47x90 Joist Hanger



Z - LUMBERLOK JH47x120 Joist Hanger P - LUMBERLOK JH47x190 Joist Hanger



E - LUMBERLOK JH95x165 Joist Hanger



O - Pair of LUMBERLOK CT200 Ceiling Ties H - LUMBERLOK CT400 Cyclone Tie

B - LUMBERLOK CT600 Cyclone Tie

M - Pair of LUMBERLOK Multi Grips



NP - LUMBERLOK Nailon Plate



N - LUMBERLOK N21 Diagonal Cleat V - SINGLE - LUMBERLOK CPC40 Cleats



W - Pair of LUMBERLOK CPC40 Cleats


K - LUMBERLOK TTP 16kN Truss to Top Plate set

G - LUMBERLOK TTP 9kN Truss to Top Plate set

# **Roof Bracing**

**LUMBERLOK Roof Bracing Specifications** brochure 08/2006 for end fixing details.

The brace must be located such that it forms an angle of 45° ± 5° to the wall

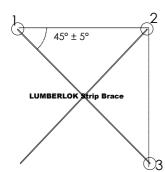

All other areas must have at the minimum 2/90x3.15mm skew nails + 2 wire dogs

**LUMBERLOK Timber Connectors Characteristic** Loadings Data brochure 03/4

Site Address

6 Rvlstone Way Te-Kauwhata Waikato

# Waikare Estate Ltd lot-69 For Building Consent Truss Fixings & Roof Bracing 10 Apr,2021 Drawn : M Newton

System : MiTek 20/20

franklin

design

rchitectural

Scale: NTS

.lob Details Roof Pitch : 25.00deg Roof Material : Longrun

Ceiling Material : Gib Board 13mm Wind Zone : High Roof Snow Load: 0.000kPa

Roof Live Load: 0.250kPa Floor Live Load Wind Speed : 44m/s Overhang : 450mm

Truss Centres : 900mm

All Trusses as shown

are at ( max 900 ctrs )

unless otherwise dimensioned

NO - Internal Wall - TRUSS Down Loadings - are greater than 10-kN so

NO - (Internal Wall Slab Thickenings) required for - TRUSS support

PrimeCad v4.7.301 BTL00031

NOTE: CONTRACTOR SHALL CONFIRM DATUM SOURCE ON SITE PLAN BEFORE COMMENCING CONSTRUCTION

CONTRACTOR SHALL VERIFY ALL DIMENSIONS ON SITE BEFORE COMMENCING CONSTRUCTION. WRITTEN DIMENSIONS SUPERSEDE SCALED DIMENSIONS. REFER TO SPECIFICATIONS FOR RELEVANT TRADE CODES/REFERENCE DOCUMENTS WHICH FORM PART OF THIS REV NO. REVISION: PO Box 11019, Palm Beach 3118

Find us at www.franklinarchitectural.co.nz

PROPOSED RESIDENCE **Waikare Estate Limited 6 RYLSTONE WAY, TE KAUWHATA** 

DRAWING TITLE **ROOF BRACING PLAN** 

KBR 20 CHECKED KB SCALE PROJECT NUMBER: 21 3710 REVISION: WD01 PLOT DATE 19/05/2021

this Layout plan - are considered to be ( TRUSS supporting )


Any INTERNAL walls as shown on

**NOTES:** 

for truss to top plate connections.

AVONDALE | EAST TAMAKI | KOPU

713 Rosebank Road Avondale Auckland phone 09-828-9791

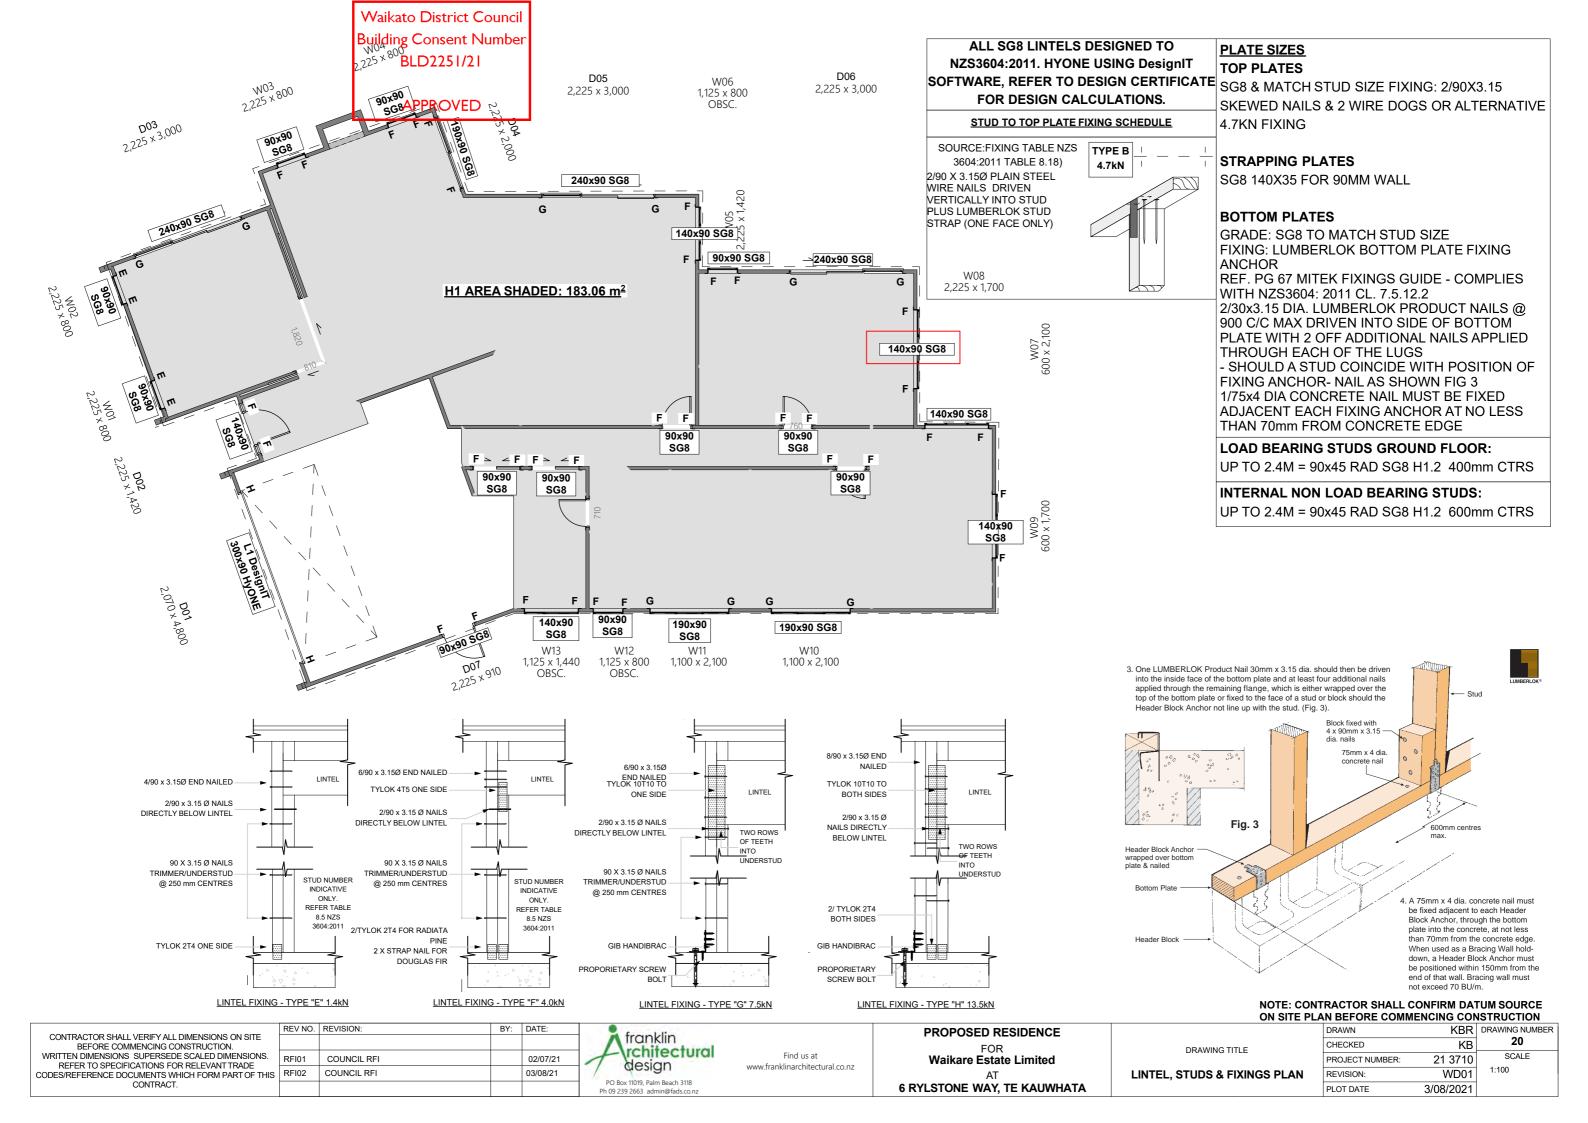

HB 3.1.5.3 Join Building Gonsent de Lumber All joints in top plates shall be made only over supports being either a stud or blocking. Joints in the top plate of a wall that does not contain any wall bracing shall be as shown in NZS 3604 figure 8.14, or be provided with an alternative fixing, having a capacity in ension or compression of 3 kN. APPROVED Halved joint fixed with 140 x 35 extra top plate 3 / 75 x 3.15 mm Top plate when used (see 8.7.4.2) Top plate 2 / 100 x 3.75 mm nails Butt or halved joint in plate shall be made over a support, i.e. (a) Stud: (b) Solid blocking fixed between studs and fixed directly under the plate, (see 8.7.3.2) (A) HALVED JOINT (B) BUTT JOINT Unless otherwise stated, all dimensions are in mm.


NZS 3604 figure 8.14 – Connecting top plates – Walls not containing bracing

Waikato District Council

For single-storey buildings, the connection in line of the top plate of a wall that contains one or more wall bracing elements shall be as shown in NZS 3604 figures 8.15 and 8.16 and HB 3604 tables 3B and 3C.

(see 8.7.3.2)

(see 8.7.3.3)

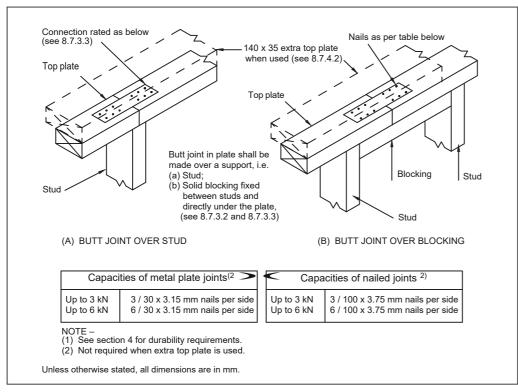

NZS 3604 figure 8.15 – Connecting top plates in line – Walls containing bracing

HB 3604 table 3B – Connections for joining top plates of bracing walls in single-storey buildings (from NZS 3604, 8.7.3.3)

Bracing capacity of wall	Connection as in figure 8.15	Alternative connection – tension or compression along the plate
100 BUs or less	3 kN	3 kN
Over 100 BUs	6 kN	6 kN
When a ceiling diaphragm is attached	6 kN	6 kN

140 x 35 extra top plate when used (see 8.7.4.2) 450 long blocking fixed to each plate with connection capacity in tables below Fix blocking to top plate and to ceiling joist Connection rated as per table below Top pla Top plate Top plate (A) BUTT JOINT (B) BUTT JOINT (WITH CEILING JOIST) Capacities of metal plate joints Capacities of nailed joints Up to 3 kN 3 / 30 x 3.15 mm nails per side 6 / 30 x 3.15 mm nails per side Up to 3 kN 3 / 100 x 3.75 mm nails per side Up to 6 kN | 6 / 100 x 3.75 mm nails per side NOTE - See section 4 for durability requirements Unless otherwise stated, all dimensions are in mm.

NZS 3604 figure 8.16 – Connecting top plates to external walls at right angles – Walls containing bracing


(see 8.7.3.4)

HB 3604 table 3C – Connections for joining top plates of bracing walls to external walls at right angles (from NZS 3604, 8.7.3.4)

Bracing capacity of wall joined to one external wall	Connection as in NZS 3604 figure 8.16
125 BUs or less	Nail plate of 6 kN
Over 125 BUs and up to 250 BUs to at least 2 external walls	Nail plate of 6 kN
250 BUs or more to at least 2 external walls	Nail plates providing a rating of not less than 2.4 kN per 100 bracing units

## NOTE: CONTRACTOR SHALL CONFIRM DATUM SOURCE ON SITE PLAN BEFORE COMMENCING CONSTRUCTION

REV NO. REVISION: KBR PROPOSED RESIDENCE CONTRACTOR SHALL VERIFY ALL DIMENSIONS ON SITE franklin 22 BEFORE COMMENCING CONSTRUCTION.
WRITTEN DIMENSIONS SUPERSEDE SCALED DIMENSIONS. CHECKED KΒ DRAWING TITLE \rchitectural Find us at SCALE **Waikare Estate Limited** PROJECT NUMBER: 21 3710 REFER TO SPECIFICATIONS FOR RELEVANT TRADE CODES/REFERENCE DOCUMENTS WHICH FORM PART OF THIS design www.franklinarchitectural.co.nz **TOP PLATE CONNECTIONS** REVISION: WD01 PO Box 11019, Palm Beach 3118 CONTRACT. **6 RYLSTONE WAY, TE KAUWHATA** PLOT DATE 19/05/2021

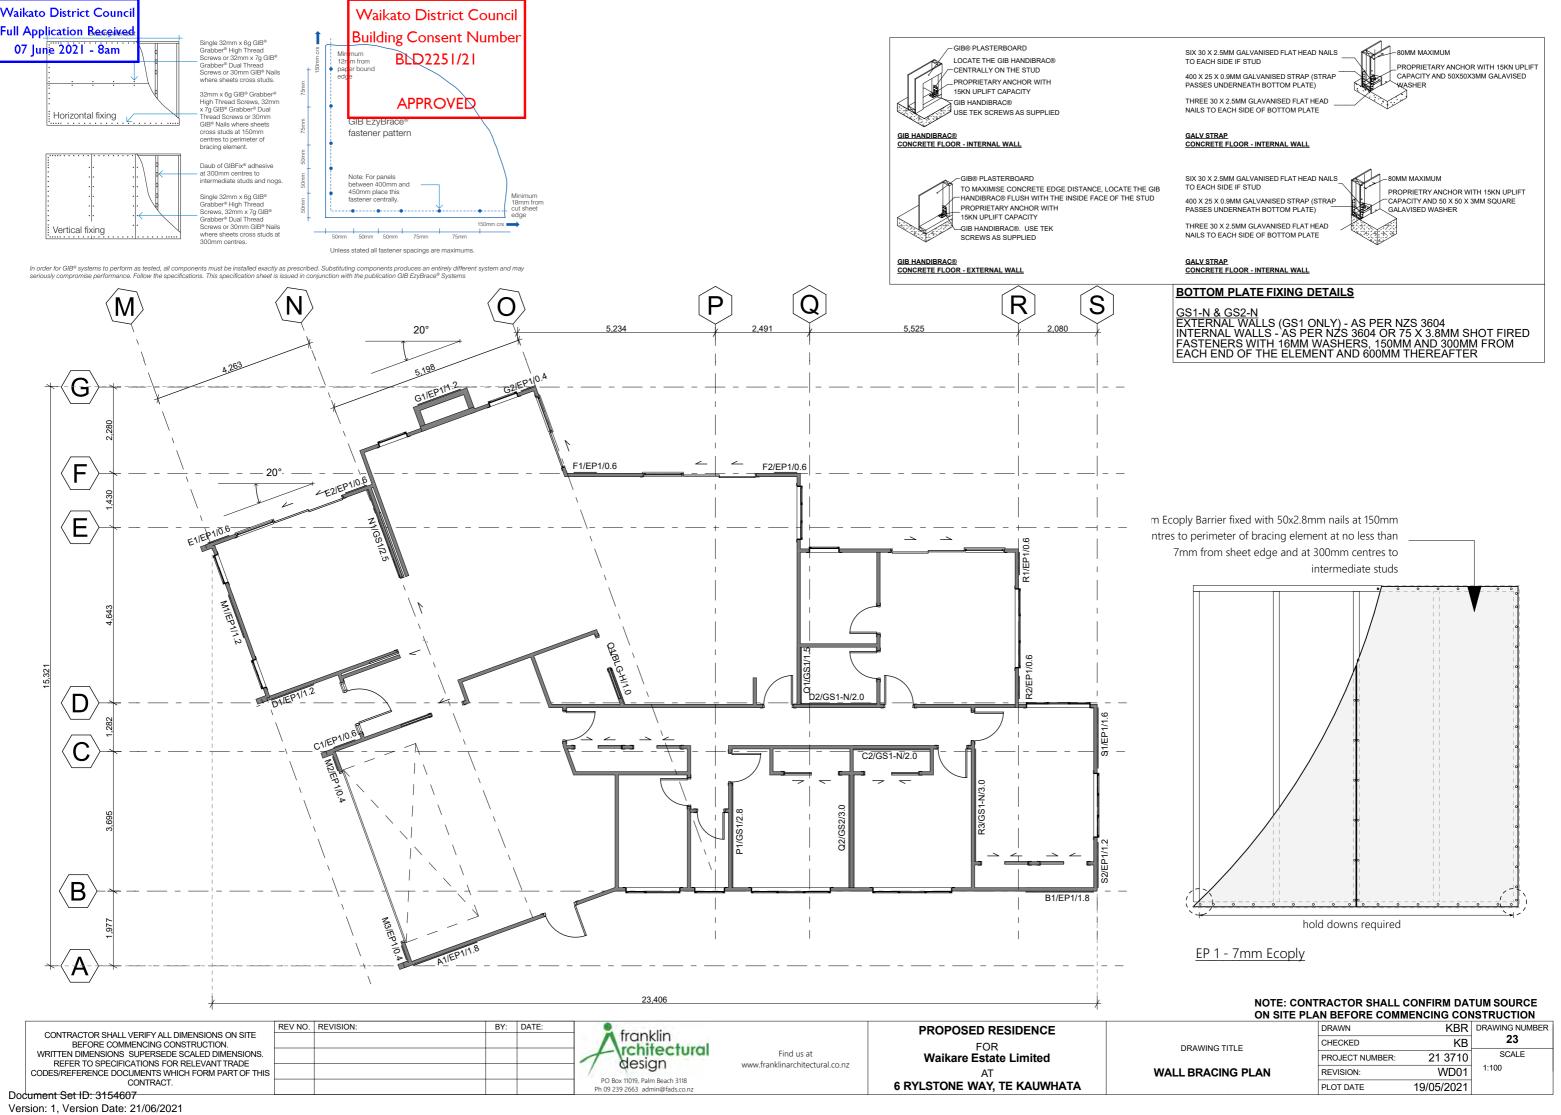

Waikato District Council Building Consent Number

# GIB EzyBrace® Bracing Software



APPROVED

# **Demand Calculation Sheet**

# Job Details

Name: 21 3710\_WAIKARE ESTATE
Street and Number: 6 Rylstone Way, Te Kauwhata

Lot and DP Number: Lot 69 D.P 513408

City/Town/District: Waikato
Designer: K. Bouman

Company: Franklin Architectural Design

Date: 25/03/21

# **Building Specification**

Number of Storeys 1
Floor Loading 2 kPa
Foundation Type Slab

Single

Cladding Weight Heavy
Roof Weight Light
Room in Roof Space No
Roof Pitch (degrees) 25
Roof Height above Eaves (m) 3.0
Building Height to Apex (m) 6.2
Ground to Lower Floor (m) 0.2

Average Stud Height (m) 2.4
Building Length (m) 23.4
Building Width (m) 15.3
Building Plan Area (m²) 228

# **Building Location**

Wind Zone = High Earthquake Zone 1

Soil Type D & E (Deep to Very Soft)

Annual Prob. of Exceedance:1 in 500 ( Default)

# **Bracing Units required for Wind**

Along Across

REV NO. REVISION:

COUNCIL RFI

Single Level 1024 1724

# **Bracing Units required for Earthquake**

Along & Across

Single Level 1065

GIB EzyBrace® Version 12/18

# GIB EzyBrace® Bracing Software



# Single Level Along Resistance Sheet

Job No	ame: 21 37	10_WAIKA	ARE ESTAT	E					Wind	EQ
									Der	mand
									1024	1065
									Ach	ieved
Line	Element	Length	Angle	Stud Ht.	Туре	Supplier	Wind	EQ	1266	1350
		(m)	(degrees)	(m)			(BUs)	(BUs)	124%	127%
	1	1.80		2.4	angled EP1_1.2	CCH	203	229		
Α							•	•	203 OK	229 OK
В	1	1.80		2.4	EP1_1.2	CHH	216	243		
В									216 OK	243 OK
	1	0.60		2.4	angled EP1_0.6	CCH	53	59		
С	2	2.00		2.4	GS1-N	GIB®	138	120		
									191 OK	179 OK
	1	1.20		2.4	angled EP1_1.2	CCH	136	152		
D	2	2.00		2.4	GS1-N	GIB®	138	120		
									274 OK	272 OK
	1	0.60		2.4	angled EP1_0.6		53	59		
E	2	0.60		2.4	angled EP1_0.6	CCH	53	59		
									107 OK	119 OK
	1	1.20	1	2.4	EP1_0.6	CHH	114	126	l	
F	2	0.60		2.4	EP1_0.6	CHH	57	63		
	<u> </u>								171 OK	189 OK
	1	1.20	1	4.4	angled EP1_1.2	CCH	74	83	l	
G	2	0.40		2.4	angled EP1_0.4	CCH	30	36	ļ	
									104 OK	119 OK

# **GIB EzyBrace® Bracing Software**



# Single Level Across Resistance Sheet

JOD N	ame: 21 37	IU_WAINA	ARE ESTAT	_					Wind	EQ
									Den	nand
									1724	1065
									Achi	eved
Line	Element	Length	Angle	Stud Ht.	Туре	Supplier	Wind	EQ	1810	1764
		(m)	(degrees)	(m)			(BUs)	(BUs)	105%	166%
	1	1.20		2.4	EP1_1.2	CHH	144	162		
М	2	0.40		2.4	EP1_0.4	CHH	32	38		
IVI	3	0.40		2.4	EP1_0.4	CHH	32	38		
									208 OK	238 OI
	1	2.50		2.4	GS1-N	GIB®	173	150		
N	2	0.40		2.4	EP1_0.4	CHH	32	38		
									205 OK	188 OI
0	1	1.00		2.4	BLG-H	GIB®	150	138		
									150 OK	138 OF
Р	1	2.80		2.4	GS1-N	GIB®	193	168		
r									193 OK	168 OI
	1	1.50		2.4	GS1-N	GIB®	104	90		
Q	2	3.00		2.4	GS2-N	GIB®	294	258		
									398 OK	348 OF
	1	0.60		2.4	EP1_0.6	CHH	57	63	[	
R	2	0.60		2.4	EP1_0.6	CHH	57	63	[	
	3	3.00		2.4	GS1-N	GIB®	207	180		
									321 OK	306 OF
	1	1.60		2.4	EP1_1.2	CHH	192	216	[	
S	2	1.20		2.4	EP1_1.2	CHH	144	162		
									336 OK	378 OF

# **GIB EzyBrace® Bracing Software**



# **Custom Wall Elements**

Supplier	System	Min. Length	Wind	EQ
		m	BUs/m	BUs/m
CHH	EP1_0.4	0.4	80	95
CHH	EP1_0.6	0.6	95	105
CHH	EP1_1.2	1.2	120	135
CCH	EPBS	0.4	60	60
ССН	angled EP1_0.4	0.4	75	89
CCH	angled EP1_0.6	0.6	89	99
CCH	angled EP1_1.2	1.2	113	127

# NOTE: CONTRACTOR SHALL CONFIRM DATUM SOURCE ON SITE PLAN BEFORE COMMENCING CONSTRUCTION

CONTRACTOR SHALL VERIFY ALL DIMENSIONS ON SITE BEFORE COMMENCING CONSTRUCTION.
WRITTEN DIMENSIONS SUPERSEDE SCALED DIMENSIONS.
REFER TO SPECIFICATIONS FOR RELEVANT TRADE
CODES/REFERENCE DOCUMENTS WHICH FORM PART OF THIS
CONTRACT.


02/07/21 franklin rchitectural design PO Box 11019, Palm Beach 3118 Ph 09 239 2663 admin@fads.co.nz

Find us at www.franklinarchitectural.co.nz


PROPOSED RESIDENCE
FOR
Waikare Estate Limited
AT
6 RYLSTONE WAY, TE KAUWHATA

DRAWING TITLE


WALL BRACING CALCULATIONS

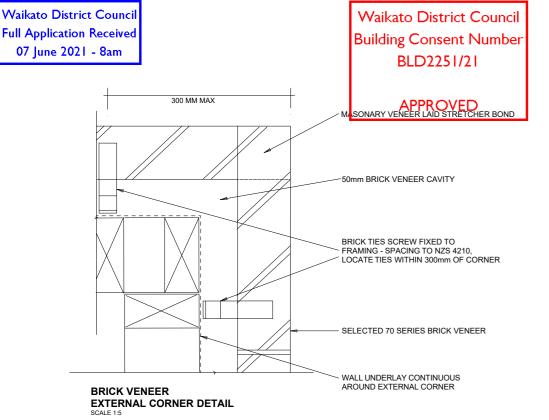


CONTROL JOINTS:
CONTROL JOINTS SHOULD BE UNDER EVERY
WINDOW AND UNDER EACH END OF WINDOWS
EXCEEDING 1.8M. CONTROL JOINTS MUST BE NO
MORE THAN 3M FROM CORNERS AND A
MAXIMUM OF 6M APART. CONTROL JOINTS MAY
BE IN A SAW TOOTH LINE.

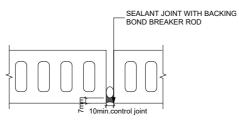

VERTICAL CONTROL JOINT SCALE 1:5

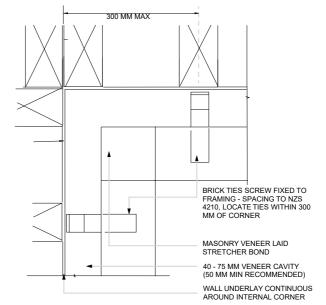



**CORNERS - INTERNAL CORNER** 

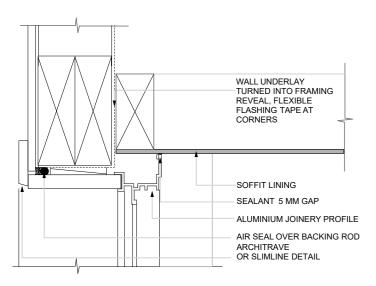

ALUMINIUM WINDOW - HEAD TO SOFFIT DETAIL

SCALE 1

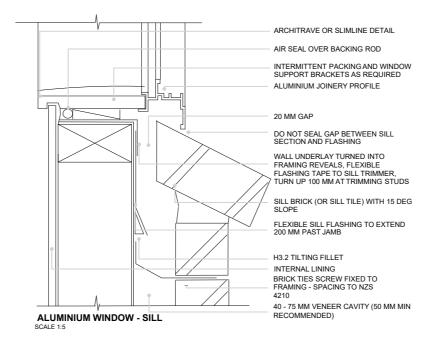

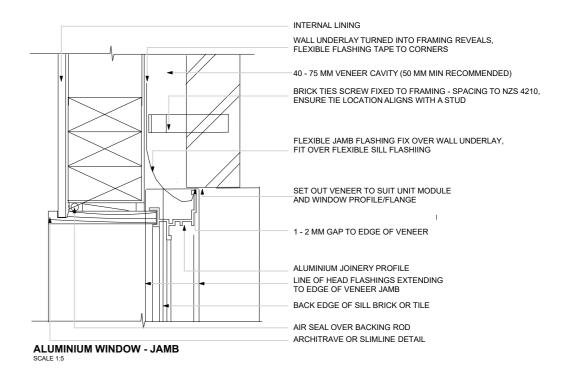


NOTE: CONTRACTOR SHALL CONFIRM DATUM SOURCE
ON SITE PLAN BEFORE COMMENCING CONSTRUCTION


	CONTRACTOR SHALL VERIFY ALL DIMENSIONS ON SITE	REVINO. REVISION:	Bī	: DATE:	franklin		PROPOSED RESIDENCE		DRAWN	KBK   DR	RAWING NUMBER	1
	BEFORE COMMENCING CONSTRUCTION.				Irankiin		FOR	DRAWING TITLE	CHECKED	KB	25	
	WRITTEN DIMENSIONS SUPERSEDE SCALED DIMENSIONS. REFER TO SPECIFICATIONS FOR RELEVANT TRADE				design	Find us at	Waikare Estate Limited	DIVAWING TITLE	PROJECT NUMBER:	21 3710	SCALE	ĺ
	CODES/REFERENCE DOCUMENTS WHICH FORM PART OF THIS				design	www.franklinarchitectural.co.nz	AT	BRICK VENEER DETAILS	REVISION:	WD01	1:5	1
_	CONTRACT.				PO Box 11019, Palm Beach 3118 Ph 09 239 2663 admin@fads.co.nz		6 RYLSTONE WAY, TE KAUWHATA		PLOT DATE	19/05/2021	1.5	

Waikato District Council
Building Consent Number
BLD2251/21


**APPROVED** 

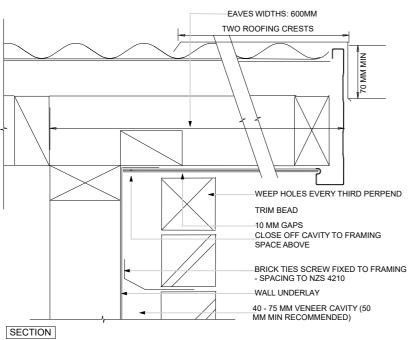

# TOP OF WALL - RAKING BARGE WITH OVERHANG

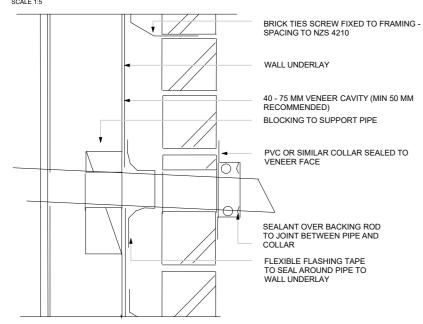

PENETRATIONS - PIPES UP TO 150 MM DIAMETER (PROTECTED LOCATION)  $_{\mbox{\scriptsize SCALE }1:5}$ 

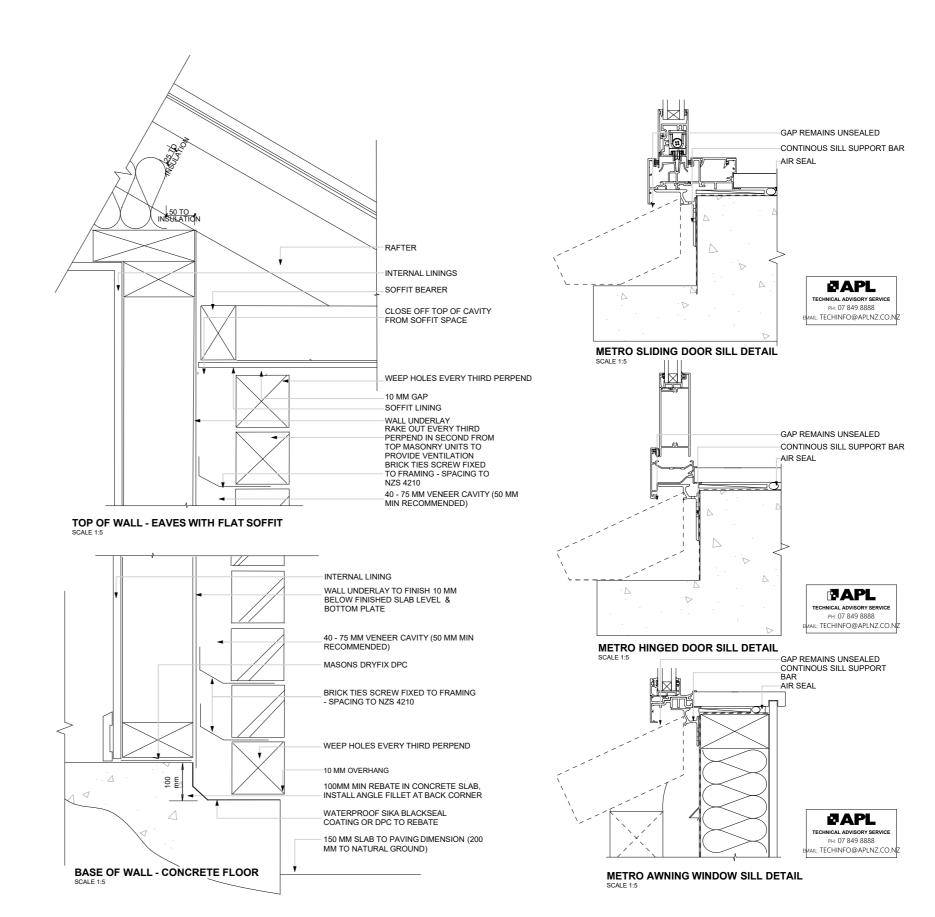

# NOTE: CONTRACTOR SHALL CONFIRM DATUM SOURCE ON SITE PLAN BEFORE COMMENCING CONSTRUCTION

CONTRACTOR CHALL VERIEVALL RIMENCIONIC ON CITE	REVINO. F	EVISION: BY	DATE:	_ '	for any lattice		PROPOSED RESIDENCE		DRAWN	KBK	DRAWING NUMBER	
CONTRACTOR SHALL VERIFY ALL DIMENSIONS ON SITE BEFORE COMMENCING CONSTRUCTION.				/	franklin		FOR	DRAWING TITLE	CHECKED	KB	26	
WRITTEN DIMENSIONS SUPERSEDE SCALED DIMENSIONS. REFER TO SPECIFICATIONS FOR RELEVANT TRADE				1	-VictilleCiulai	Find us at	Waikare Estate Limited	DIAWING TITLE	PROJECT NUMBER:	21 3710	SCALE	
CODES/REFERENCE DOCUMENTS WHICH FORM PART OF THIS					design	www.franklinarchitectural.co.nz	AT	BRICK VENEER DETAILS	REVISION:	WD01	1:5	
CONTRACT.					O Box 11019, Palm Beach 3118 09 239 2663 admin@fads.co.nz		6 RYLSTONE WAY, TE KAUWHATA		PLOT DATE	19/05/2021		

Full Application Received **Building Consent Number** 07 June 2021 - 8am BLD2251/21 -LINEA® WEATHERBOARD -H3.1 TREATED TIMBER CANT STRIF TIMBER CAVITY BATTEN JAMES HARDIE UPVC VENT STRIP PROPRIETARY TAPE OR A TERNATIVEL ARPROVED LAYER OF FLEXIBLE UND RLAY OVER HEAD FLASHING FACE NAIL WEATHERBOARDS TO LINTEL -LINTEL SELECTED INTERIOR LINING FOR FIXING OVER JAMES HARDIE RIGID AIR BARRIER OR FLEXIBLE UNDERLAY REFER TO FIXING TABLE 3 FLASHING TAPE OVER UNDERLAY REQUIRED IN CORNERS ONLY FLEXIBLE SEALANT OVER PEF ROD TO FORM WATERPROOF AIRSEAL WINDOW LINER TEMPORARY PACKERS IF REQUIRED TO BE WINDOW FRAME (REFER TO WINDOW -MANUFACTURER FOR METHOD OF SUPPORT AND

ALUMINIUM HEAD FLASHING TO MIN 15° SLOPE

Waikato District Council

### NOTE

Waikato District Counci

- WHEN JAMES HARDIE RIGID AIR BARRIER IS USED FLASHING TAPE TO BE APPLIED TO THE


  ENTIRE MUNICIPALITY

  FOR THE PROPERTY OF THE PROPERTY OF
- ENTIRE WINDOW OPENING.

  SEALANT MUST BE INSTALLED BETWEEN HEAD FLASHING AND FLASHING AND TRIM IN VH
- AND EH WIND ZONES AND SED PROJECTS.


  ALTERNATIVELY, THE HEAD FLASHINGS CAN BE FORMED WITH STOP ENDS AS PER E2/AS1

## TIMBER CAVITY WINDOW AND DOOR HEAD WITHOUT FACINGS

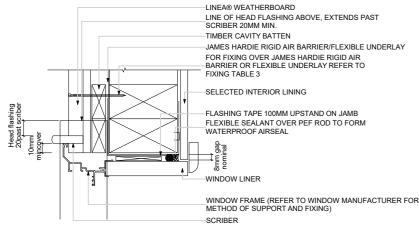

NOTE: WHEN JAMES HARDIE RIGID AIR BARRIER IS USED FLASHING TAPE TO BE APPLIED TO THE ENTIRE WINDOW OPENING.


## TIMBER CAVITY WINDOW AND DOOR JAMB WITHOUT FACINGS

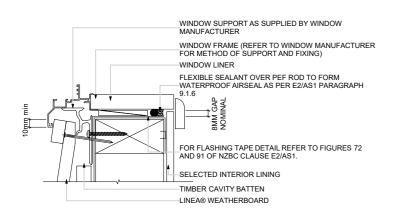

TIMBER CAVITY WINDOW AND DOOR SILL WITHOUT FACINGS





## **BEVEL-BACK TIMBER WEATHERBOARDS - EXTERNAL CORNER**

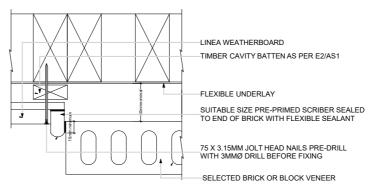


NOTE: BRICK TIE TO BE FIXED 70MM MINIMUM FROM THE EDGE OF BRICK. REFER TO MANUFACTURERS INSTALLATION

# VERTICAL JUNCTION BETWEEN LINEA WEATHERBOARD ON CAVITY AND BRICK VENEER SCALE 1-5

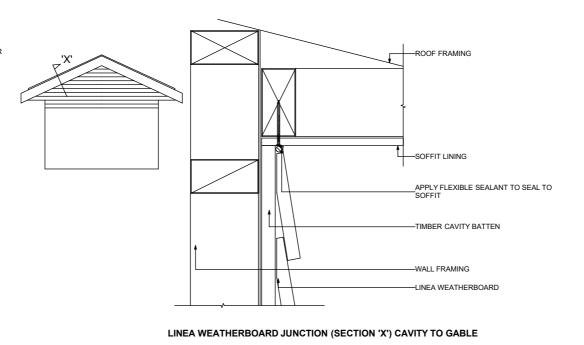

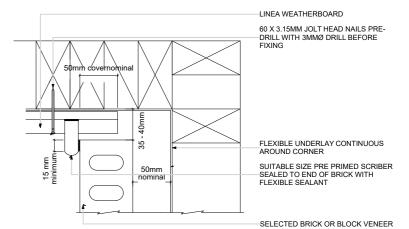

INTERNAL CORNER JUNCTION BETWEEN LINEA WEATHERBOARD AND BRICK VENEER

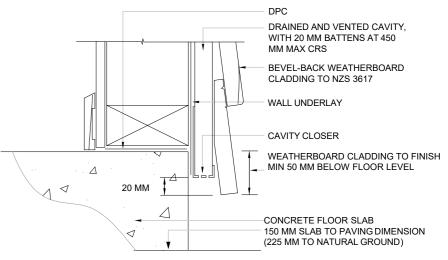



BEVEL-BACK TIMBER WEATHERBOARDS - CONCRETE FLOOR


# NOTE: CONTRACTOR SHALL CONFIRM DATUM SOURCE ON SITE PLAN BEFORE COMMENCING CONSTRUCTION


	REV NO. REVISION:	BY: DATE:	•		PROPOSED RESIDENCE		DRAWN	KBR	DRAWING NUMBER
CONTRACTOR SHALL VERIFY ALL DIMENSIONS ON SITE			n tranklin		I NOI COLD INLOIDLINGL				27
BEFORE COMMENCING CONSTRUCTION.			/ vobito otrival		FOR	DRAWING TITLE	CHECKED	KB [	21
WRITTEN DIMENSIONS SUPERSEDE SCALED DIMENSIONS.			\rcnitectural	Find us at	Waikare Estate Limited	DIAWING TITLE	DDO IECT NILIMBED:	21 3710	SCALE
REFER TO SPECIFICATIONS FOR RELEVANT TRADE			design	www.franklinarchitectural.co.nz	Walkare Estate Limiteu		PROJECT NUMBER.	21 37 10	
CODES/REFERENCE DOCUMENTS WHICH FORM PART OF THIS			dosign	www.nankinarcintectara.co.nz	ΔΤ	CLADDING DETAILS	REVISION:	WD01	4.5
CONTRACT.			PO Box 11019, Palm Beach 3118		^ \\	02/155/11/0/52/1/4/20			1:5
CONTRACT			Ph 09 239 2663 admin@fads.co.nz		6 RYLSTONE WAY, TE KAUWHATA		PLOT DATE	19/05/2021	

Waikato District Council
Building Consent Number
BLD2251/21

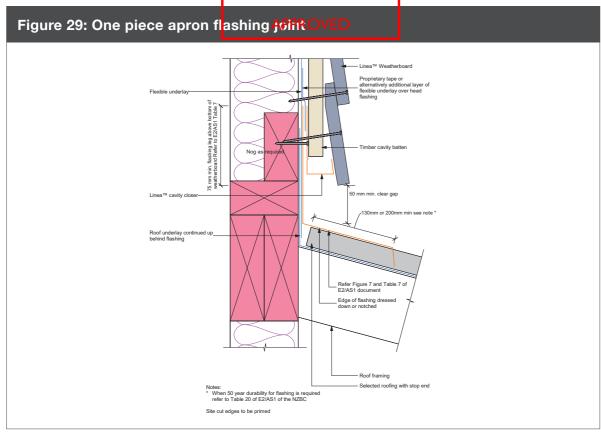

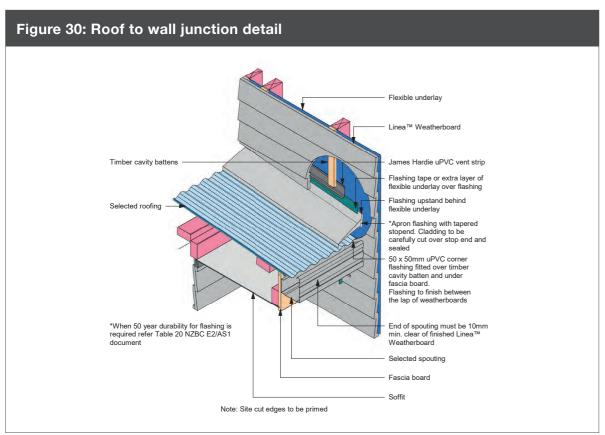

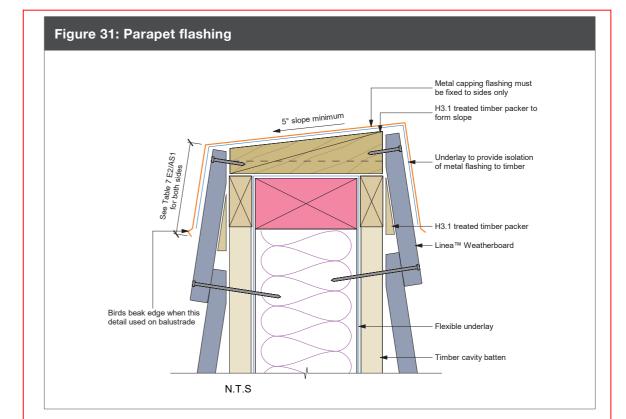

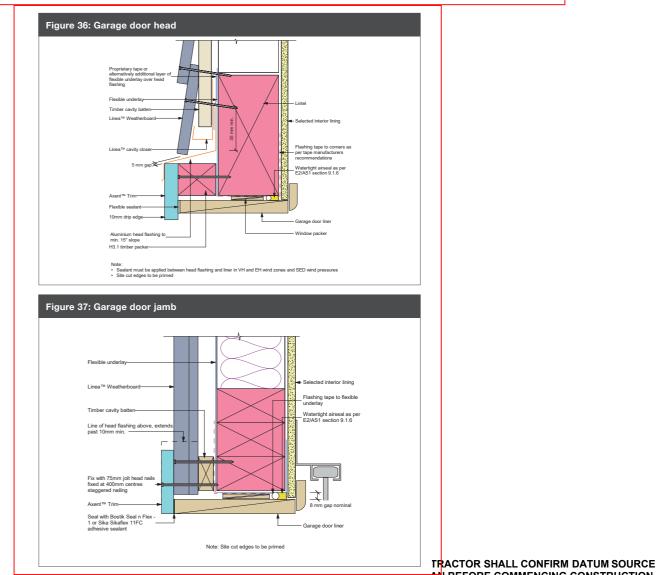

CONTRACTOR SHALL VERIFY ALL DIMENSIONS ON SITE
BEFORE COMMENCING CONSTRUCTION.
WRITTEN DIMENSIONS SUPERSEDE SCALED DIMENSIONS.
REFER TO SPECIFICATIONS FOR RELEVANT TRADE
CODES/REFERENCE DOCUMENTS WHICH FORM PART OF THIS
CONTRACT.

franklin rchitectural design
PO Box 11019, Palm Beach 3118
Ph 09 239 2663 admin@fads.conz

Find us at www.franklinarchitectural.co.nz

PROPOSED RESIDENCE
FOR
Waikare Estate Limited
AT
6 RYLSTONE WAY, TE KAUWHATA


DRAWING TITLE

CLADDING DETAILS


Waikato District Council

STORAGE HOT WATER SYSTEM REQUIREMENTS

HOT WATER PIPES SHALL BE INSULATED TO NZS4505 AS MODIF ED BY H1/AS1 5.0

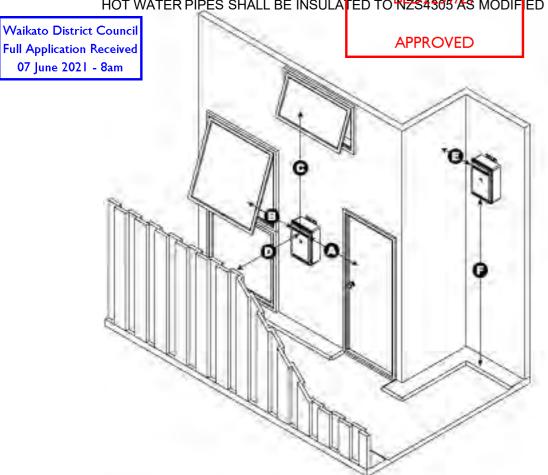


GAS	<b>WATER HEATER EXTE</b>	RNAL CLEARANCES
Dimension	Infinity %R models Infinity HD200 Ext Efficiency models	Infinity HD250 Ext
A	Min, 300 mm	Min 500 mm
В	Min 300 mm	Min 500 mm
- C	Min. 1.5 m	Min 1.5 m
D	Min.500 mm	Min.500 min
E	Min. 300 mm	Min. 300 mm
F	Min. 300 mm	Min 300 mm

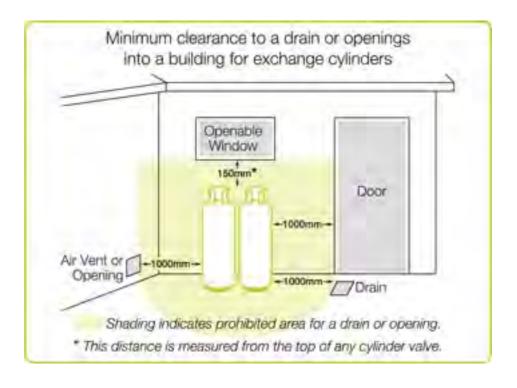


# gas bottle position to openings


# WATER PROOFING

ARDEX WATERPROOFING WPM 002 SUPERFLEX BATHROOM AND BALCONY MEMBRANE SYSTEM & FLOOR TILING SYSTEM SHALL BE PROVIDED TO ALL WET AREAS BELOW FLOOR OVERLAYS INSTALLED TO MANUFACTURERS REQUIREMENTS BY AN APPROVED INSTALLER, REFER SPECIFICATIONS.

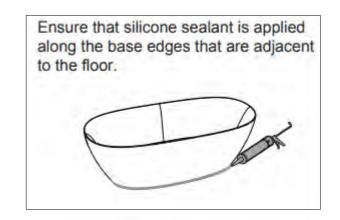


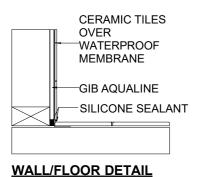


**BATHROOM - TILED WALLS** 

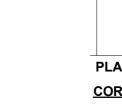



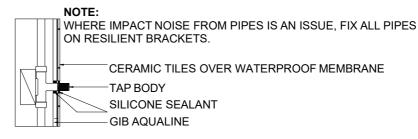

# **PENETRATION DETAIL** SHOWER/BATH - TILED WALLS/UPSTAND SCALE 1:10

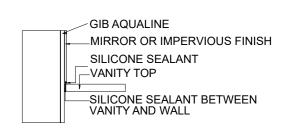

**VANITY TOP DETAIL SCALE 1:10** 


NOTE: CONTRACTOR SHALL CONFIRM DATUM SOURCE ON SITE PLAN BEFORE COMMENCING CONSTRUCTION


CONTRACTOR SHALL VERIFY ALL DIMENSIONS ON SITE	REV NO	. REVISION:	BY:	DATE:	franklin		PROPOSED RESIDENCE		DRAWN	KBR	DRAWING NUMBER
BEFORE COMMENCING CONSTRUCTION.					rehitoetural		FOR	DRAWING TITLE	CHECKED	KB	29
WRITTEN DIMENSIONS SUPERSEDE SCALED DIMENSIONS. REFER TO SPECIFICATIONS FOR RELEVANT TRADE					design	Find us at	Waikare Estate Limited	DIVINING TITLE	PROJECT NUMBER:	21 3710	SCALE
CODES/REFERENCE DOCUMENTS WHICH FORM PART OF THIS					design	www.franklinarchitectural.co.nz	AT	<b>HWS &amp; WET AREA DETAILS</b>	REVISION:	WD01	1:1 1:10
CONTRACT.					PO Box 11019, Palm Beach 3118 Ph 09 239 2663, admin@fads.co.nz		6 RYLSTONE WAY, TE KAUWHATA		PLOT DATE	19/05/2021	1 1.1, 1.10


Document Set ID: 3154607 Version: 1, Version Date: 21/06/2021


Waikato District Council
Building Consent Number
BLD2251/21


APPROVED

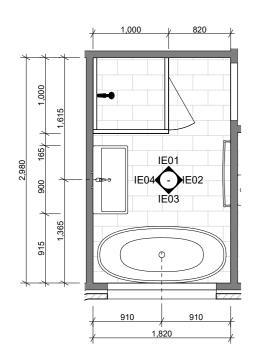

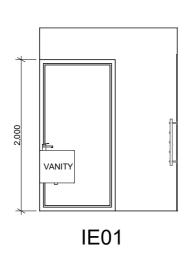


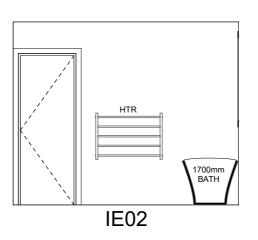


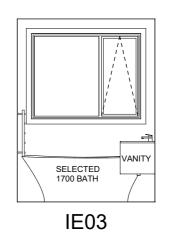


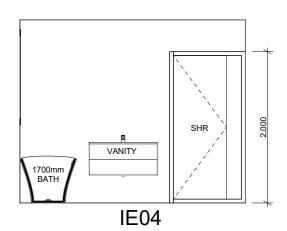



**BATHROOM LAYOUT** 

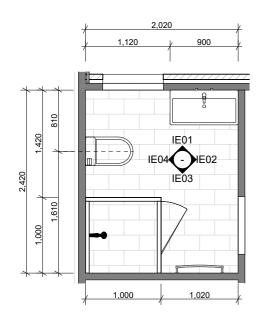

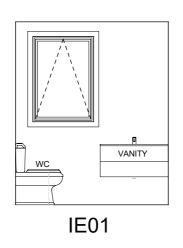

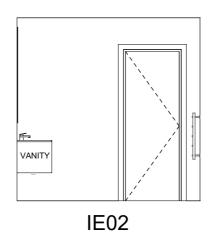

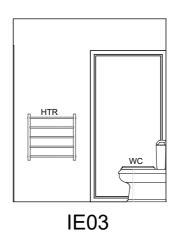

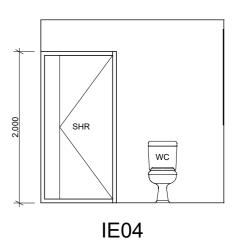

**ENSUITE LAYOUT** 

# NOTE: CONTRACTOR SHALL CONFIRM DATUM SOURCE ON SITE PLAN BEFORE COMMENCING CONSTRUCTION

CONTRACTOR SHALL VERIFY ALL DIMENSIONS ON SITE
BEFORE COMMENCING CONSTRUCTION.
WRITTEN DIMENSIONS SUPERSEDE SCALED DIMENSIONS.
REFER TO SPECIFICATIONS FOR RELEVANT TRADE
CODES/REFERENCE DOCUMENTS WHICH FORM PART OF THIS
CONTRACT.

REV NO. REVISION:

BY: DATE:

franklin
rchitectu
design

PO Box 11019, Palm Beach 3118
Ph 09 239 2663 admin@fads.com

franklin rchitectural Find us at design www.franklinarchitectural.co.nz PROPOSED RESIDENCE
FOR
Waikare Estate Limited
AT
6 RYLSTONE WAY, TE KAUWHATA

DRAWING TITLE	
BATHROOM LAYOUTS & ELEVATIONS	

Waikato District Council **Building Consent Number** BLD2251/21

	H1 - W	ALL SCHE DUL		CE INDICATION ONL	Y CLADDING N	IOT INCLUDED	
ID	WALL HEIGHT	WALL LENGTH	APPROVED WALL THICKNESS	WALL SURFACE AREA	NUMBER OF DOORS	NUMBER OF WINDOWS	GROSS SURFACE AREA OF OPENINGS
h1,	2,460	365.7	90	0.90	0	0	0.00
h1,	2,460	580.0	90	1.43	0	0	0.00
h1,	2,460	1,423.4	90	3.50	0	0	0.00
h1,	2,460	2,110.0	90	5.19	0	0	0.00
H1	2,460	950.0	90	2.34	0	0	0.00
H1	2,460	2,080.0	90	5.12	0	1	3.78
H1	2,460	2,360.0	90	5.81	0	0	0.00
H1	2,460	2,440.9	90	6.00	1	0	4.45
H1	2,460	4,110.0	90	10.11	0	1	1.26
H1	2,460	4,920.0	90	12.10	1	0	6.68
H1	2,460	5,769.6	90	14.19	1	1	7.58
H1	2,460	12,749.6	90	31.36	0	4	7.14
H1	4,460	4,940.0	90	15.00	0	1	1.02
H1	6,460	1,720.0	90	4.92	0	1	1.78
H1	6,460	1,720.0	90	4.92	0	1	1.78
H1,	2,460	825.1	90	2.03	0	0	0.00
H1,	2,460	1,094.7	90	2.69	1	0	1.62
H1,	2,460	1,097.8	90	2.70	0	0	0.00
H1,	2,460	2,830.0	90	6.96	1	0	0.00
H1,	2,460	3,070.0	90	7.55	0	0	0.00
H1.	2,460	1,790.0	90	4.40	1	0	3.16
H1.	2,460	2,000.0	90	4.92	0	1	3.16
H1.	2,460	6,167.3	90	15.17	1	0	6.68
H1.	4,460	4,220.0	90	12.66	0	2	3.56
	-	-		181.97 m²			53.65 m²

			DOOR SCHEDU	LE				
ID	D01	D02	D03	D04	D05	D06	D07	
HEIGHT	2,070	2,225	2,225	2,225	2,225	2,225	2,225	
WIDTH	4,800	1,420	3,000	2,000	3,000	3,000	910	
SILL HEIGHT	0	0	0	0	0	0	0	
HEAD HEIGHT	2,070	2,225	2,225	2,225	2,225	2,225	2,225	
View from Opening Side		s	s s s	s s	s s s			

## **GENERAL:**

- SITE MEASURE ALL JOINERY & CHECK PRIOR TO CONSTRUCTION
- WINDOW SUITE DESIGN TO ALLOW FOR HIGH WIND ZONE.

## JOINERY:

- FINISH TO BE POWDER COATED ALUMINIUM (SCRATCHED JOINERY WILL BE REJECTED)
- FLUSH JAMBS WITH PLANTED ARCHITRAVÉS, REFER DETAILS/SPEC

## HARDWARE:

TO LATER SCHEDULE TO OWNERS APPROVAL

# GLASS:

- ALL GLASS TO NZS 4223 PART 3 AND SHALL COMPLY WITH AS1/F2 HAZARDOUS BUILDING MATERIALS
- DOUBLE GLAZING AS PER H1 REQUIREMENTS SHALL BE PROVIDED TO ALL WINDOWS AND DOORS EXPECT GARAGE DOOR & WINDOWS

## INSTALLATION:

- BUILDING PAPER SHALL BE FOLDED INTO PERIMETER OF ALL OPENINGS TO INSIDE FACE OF FRAMING.
- ALL CORNERS SHALL BE TAPED /FLEXIBLE FLASHING TAPE APPLIED TO HEAD/ SILL WITH SELECTED TAPE SYSTEM.
- HEAD/ SILL & JAMB FLASHINGS THROUGHOUT ALL TO E2/AS1 APPROVED INSTALLATION
- SILL BARS: ALL DOORS/ WINDOWS WITH TRIM OPENING WIDER THAN 600mm

## WINDOW MANUFACTURER SHALL CONFIRM BEFORE COMMENCING FABRICATION:

- DOOR REBATES WITH OWNER/ PROJECT MANAGER
- OPENINGS & JOINERY SIZES SHALL BE VERIFIED ON SITE
- FINAL GLAZING SPECIFCATION AND TINT SPECIFICATION

# TABLE 3.D4 HUMAN IMPACT SAFETY REQUIREMENTS FOR GLAZED PANELS & WINDOWS IN BATHROOMS

PANEL DETAILS	HUMAN IMPACT SAFETY REQUIREMENTS
FRAMED SHOWER SCREEN & BATH ENCLOSURES	GRADE A SAFETY GLAZING MATERIAL IN ACCORDANCE WITH TABLE 3.1 (308.1(A))
PANELS & DOORS WITH ONE UNFRAMED EDGE	TOUGHENED SAFETY GLASS MINIMUM THICKNESS 5mm (308.2)
FRAMELESS PIVOT OR HINGE DOORS	TOUGHENED SAFETY GLASS MINIMUM THICKNESS 6mm (308.4)
GLAZING WITHIN 1500mm ABOVE THE ABUTTING FINISHED FLOOR LEVEL OR STANDING AREA OF A BATH OR SHOWER	GRADE A SAFETY GLAZING MATERIAL IN ACCORDANCE WITH TABLE 3.1 (308.1 (B))
GLAZING GREATER THAN 1500mm ABOVE THE ABUTTING FINISHED FLOOR LEVEL OR STANDING AREA OF A BATH OR SHOWER	ANNEALED GLASS TO NZS 4223:PART 4

# OBSC = OBSCURE GLASS S = SAFETY GLASS ALL JOINERY SHALL BE MEASURED ON SITE BEFORE COMMENCING **FABRICATION**

WINDOW SCHEDULE													
ID	W01	W02	W03	W04	W05	W06	W07	W08	W09	W10	W11	W12	W13
HEIGHT	2,225	2,225	2,225	2,225	2,225	1,125	600	2,225	600	1,100	1,100	1,125	1,125
WIDTH	800	800	800	800	1,420	800	2,100	1,700	1,700	2,100	2,100	800	1,440
HEAD HEIGHT	2,225	2,225	2,225	2,225	2,225	2,225	2,225	2,225	2,225	2,225	2,225	2,225	2,225
SILL HEIGHT	0	0	0	0	0	1,100	1,625	0	1,625	1,125	1,125	1,100	1,100
AREA	1.78	1.78	1.78	1.78	3.16	0.90	1.26	3.78	1.02	2.31	2.31	0.90	1.62
ALL VIEWS SHALL BE CONFIRMED BEFORE COMMENCING CONSTRUCTION		s	s	s	SSS	OBSC.		S S S				OBSC.	S S OBSC.

					NOTE: CONTRACTOR SHALL CONFIRM DAT	TUM SOURCE
					ON SITE PLAN BEFORE COMMENCING CON	ISTRUCTION
ONITE A CTOR CLIALL MEDICAL DIMENSIONS ON CITE	REV NO. REVISION:	BY: DATE:	fuera lelia	PROPOSED RESIDENCE	DRAWN KBR	DRAWING NUMBER

CONTRACTOR SHALL VERIFY ALL DIMENSIONS ON SITE BEFORE COMMENCING CONSTRUCTION. WRITTEN DIMENSIONS SUPERSEDE SCALED DIMENSIONS. tranklin 31 CHECKED KB FOR DRAWING TITLE \rchitectural Find us at SCALE **Waikare Estate Limited** PROJECT NUMBER: 21 3710 REFER TO SPECIFICATIONS FOR RELEVANT TRADE CODES/REFERENCE DOCUMENTS WHICH FORM PART OF THIS design www.franklinarchitectural.co.nz 1:1.1111, 1:1.2658, WINDOW, DOOR & H1 SCHEDULES REVISION: WD01 PO Box 11019, Palm Beach 3118 CONTRACT. **6 RYLSTONE WAY, TE KAUWHATA** PLOT DATE 19/05/2021 Ph 09 239 2663 admin@fads.co

